

DA000	COVER SHEET
DA001	FACADE COLOUR CONCEPT
DA002	PERSPECTIVES
DA021	SITE ANALYSIS
DA101	SITE PLAN - NEW WORKS
DA161	SHADOW DIAGRAMS
DA201	BASEMENT LEVEL
DA202	GROUND FLOOR
DA203	LEVEL 1
DA204	LEVEL 2
DA205	ROOF PLAN
DA401	ELEVATIONS NORTH WING
DA402	ELEVATIONS SOUTH WING
DA403	ELEVATIONS WEST WING
DA404	DETAILED ELEVATION & WALL SECTIONS
DA501	SECTIONS



## General Notes

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Robert Macindoe Nominated Architect NSW ARB 4699



Client  
OPAL SPECIALIST AGED CARE  
Level 27, 135 King Street

Sydney, NSW 2000  
T- (02) 8241 1609



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Project  
OPAL HILLSIDE - LAKE MACQUARIE

Project Address  
3 Violet Town Road, Mount Hutton NSW  
2290, Australia

COVER PAGE

Project Number Drawing Number Issue


Project Number	Drawing	File Name
502779	DA0001	





ANGOPHORA COSTATA


SITE FEATURES

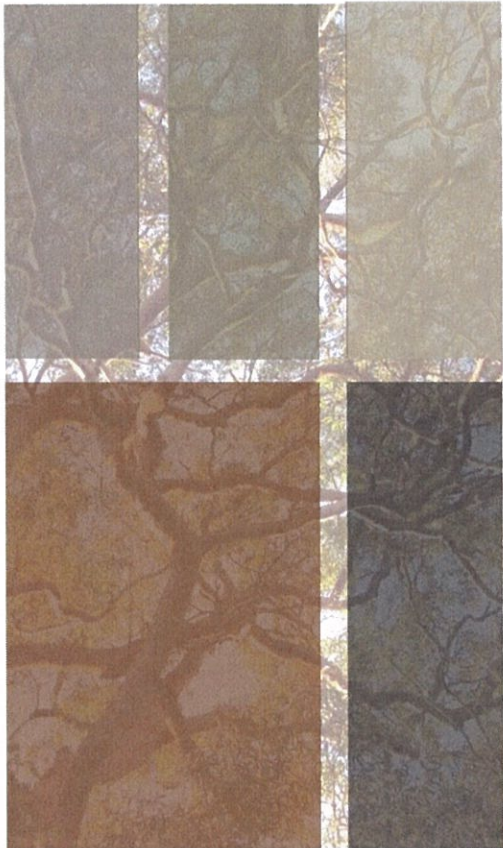


PAPERBARK  
SOFFIT LINING



CONCRETE SLAB EDGES  
- PROVIDE HORIZONTAL FIRE SEPARATION

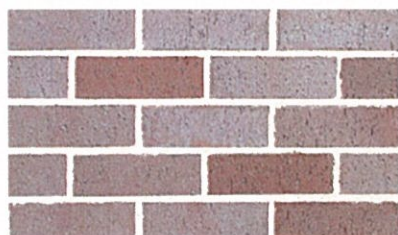

PGH - BLUE STEEL FLASH

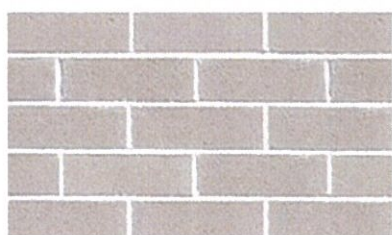

PGH - MOONDUST



ADBRI MASONRY Trihex - PAVERS


PROPOSED MATERIAL PALETTE

MONUMENT  
LIGHTWEIGHT CLADDING  
TYPE 2

WALLABY  
LIGHTWEIGHT CLADDING  
TYPE 1

WALLABY - DOWNPIPES, ROOF SHEETING & GUTTERS

TERRAIN OR SIMILAR - PERFORATED METAL SUNSCREENS

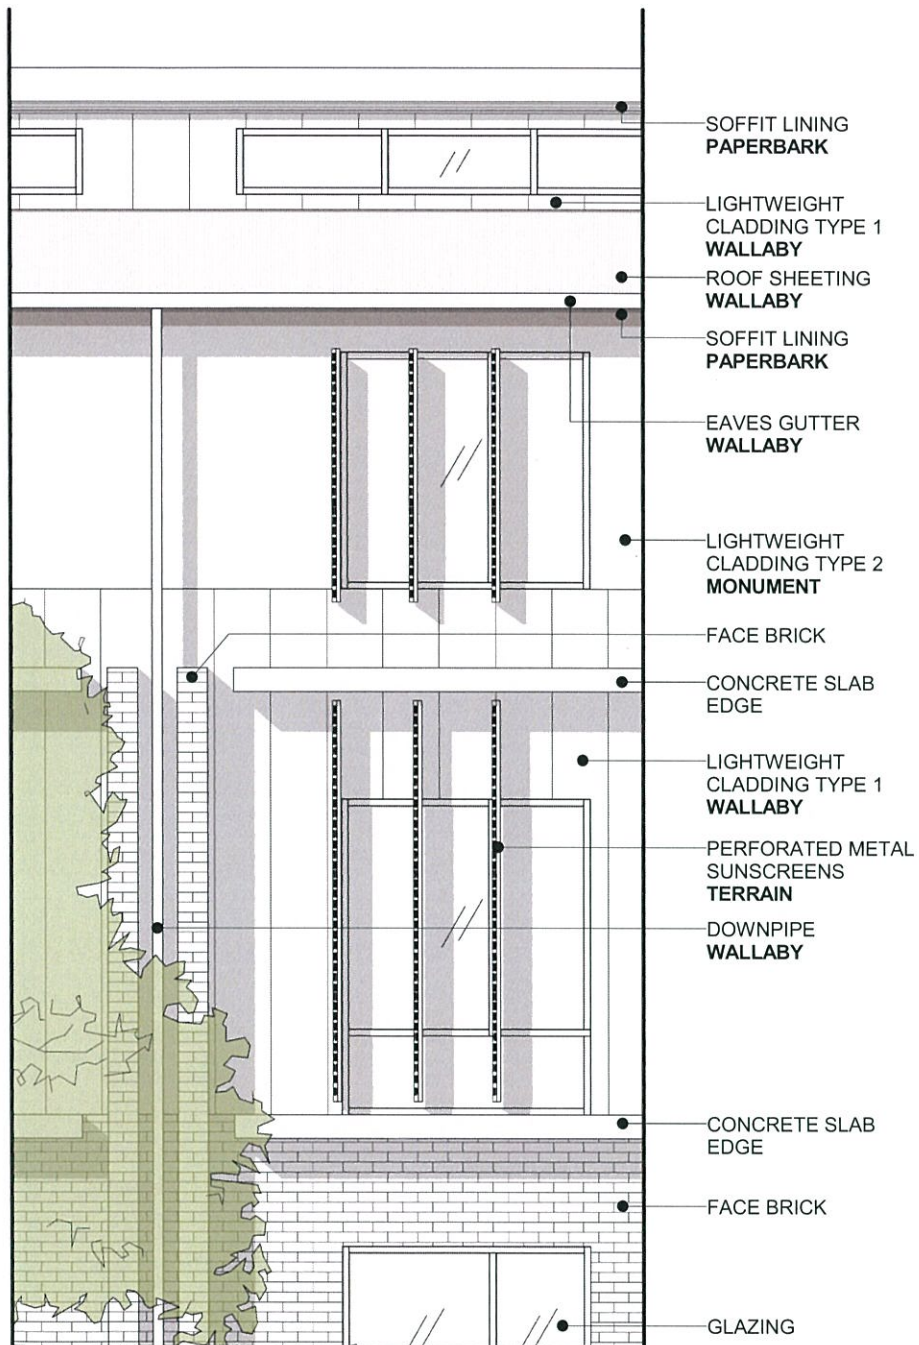

ELEVATION ELEMENTS



PRECEDENT IMAGES - METAL SCREEN







PANORAMA 1 - INTERNAL ROAD ENTRY LOOKING EAST



PANORAMA 2 - VIOLET TOWN ROAD LOOKING EAST



PANORAMA 3 - CORNER OF WILSON AND VIOLET TOWN ROADS LOOKING SOUTH



PANORAMA 4 - VIOLET TOWN ROAD LOOKING SOUTH EAST


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1	ISSUE FOR DA	12/08/14	RP	JH
Issue	Description	Date	Chk	Auth
Architect	dwp@suters.com.au			
Project	OPAL HILLSIDE - LAKE MACQUARIE			
Location	3 Violet Town Road, Mount Hutton NSW 2290, Australia			
Client	Opal specialist aged care			
Drawing	PERSPECTIVES			
Scale	@ A1	Date Printed	13/08/2014 4:30:44 PM	
Project Number	502779	Drawing Number	DA002	Issue
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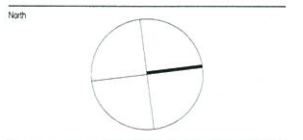


3 100\_SITE ANALYSIS  
DA401 1:1000

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#### LEGEND

- EXISTING DRIVEWAY & CAR PARKING
- PROPOSED DRIVEWAY & CAR PARKING
- TO BE REMOVED/DEMOLISHED
- REFER TO LANDSCAPE DRAWINGS FOR EXISTING TREES TO BE REMOVED
- EXISTING TREES TO BE RETAINED

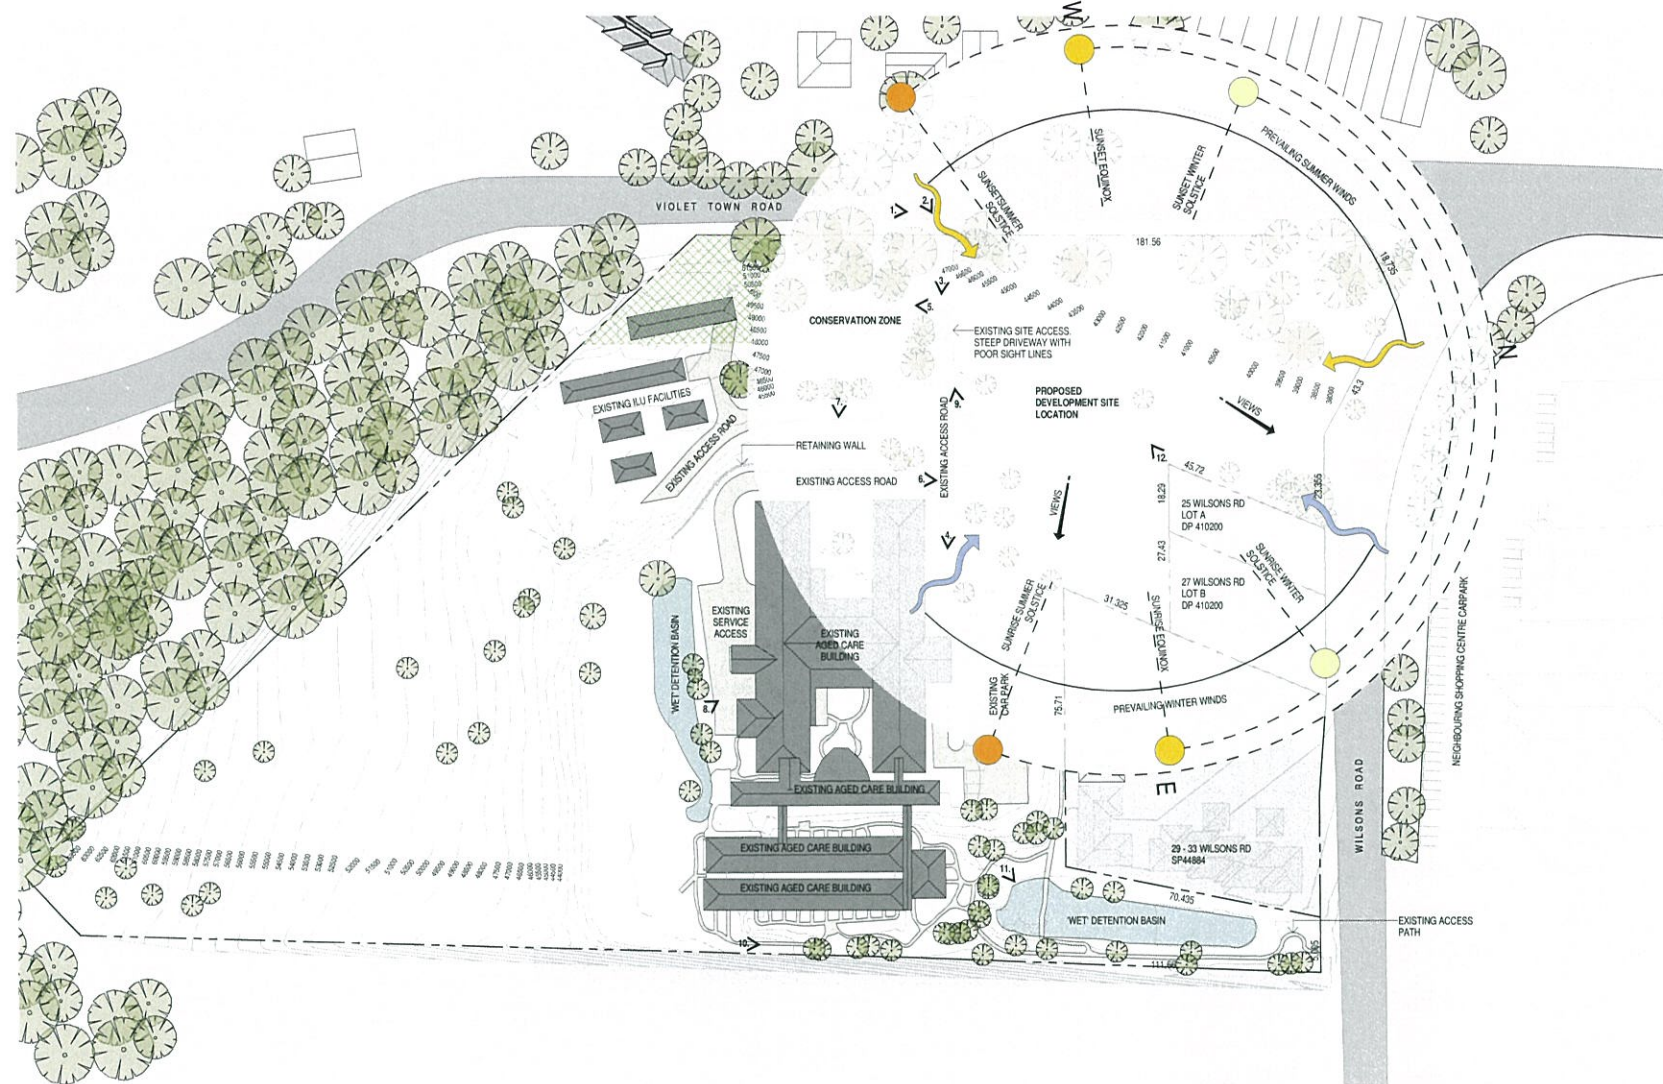

01. VIEW FROM VIOLET TOWN ROAD LOOKING TOWARDS THE EXISTING ENTRANCE TO THE AGED CARE FACILITY

02. VIEW FROM VIOLET TOWN ROAD LOOKING FROM THE EXISTING VIOLET TOWN ROAD ENTRANCE TOWARDS THE PROPOSED DEVELOPMENT SITE LOCATION

03. VIEW FROM VIOLET TOWN ROAD LOOKING FROM THE EXISTING VIOLET TOWN ROAD ENTRANCE DOWN THE EXISTING DRIVEWAY TOWARDS THE EXISTING AGED CARE FACILITY

04. VIEW TOWARDS THE CAR PARK AND ENTRANCE OF THE EXISTING AGED CARE FACILITY

05. VIEW TOWARDS CONSERVATION ZONE AT THE SOUTH WEST PORTION OF THE SITE

06. VIEW NORTH TOWARDS THE PROPOSED DEVELOPMENT SITE LOCATION, EXISTING FACILITY ENTRANCE TO THE LEFT, EXISTING CAR PARKING AND EXISTING FACILITY TO THE RIGHT

07. VIEW FROM THE PROPOSED CAR PARKING LOCATION AT THE SOUTH WEST PORTION OF THE SITE TO THE EXISTING AGED CARE FACILITY

08. VIEW OF THE REAR (BACK OF HOUSE) AREA OF THE EXISTING AGED CARE FACILITY

09. VIEW OF EXISTING AGED CARE FACILITY DRIVEWAY TOWARDS VIOLET TOWN ROAD

10. VIEW OF EXISTING ASSISTED LIVING UNIT FACILITY (ALU'S)

11. VIEW OF EXISTING EASTERN WET DETENTION BASIN

12. VIEW SOUTH OF THE PROPOSED DEVELOPMENT SITE LOCATION, EXISTING FACILITY ENTRANCE TO THE RIGHT, EXISTING CAR PARKING AND EXISTING FACILITY TO THE LEFT

1	ISSUE FOR DA	12/08/14	RP	JH
Issue	Description	Date	Chk	Auth
Architect	dwp suters			
	www.dwpsuters.com			
Project	OPAL HILLSIDE - LAKE MACQUARIE			
Location	3 Violet Town Road, Mount Hutton NSW 2290, Australia			
Client				
Drawing	SITE ANALYSIS			
Scale	As indicated @ A1	Date Printed	13/08/2014 4:31:12 PM	
Project Number	502779	Drawing Number	DA021	Issue
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#### LEGEND

- EXISTING DRIVEWAY & CAR PARKING
- PROPOSED DRIVEWAY & CAR PARKING
- TO BE REMOVED/DEMOLISHED


REFER TO LANDSCAPE DRAWINGS FOR EXISTING TREES TO BE REMOVED

EXISTING TREES TO BE RETAINED

GROSS FLOOR AREA (GFA)	
LEVEL	AREA
LOWER GROUND	705.250 m <sup>2</sup>
GROUND FLOOR	1656.438 m <sup>2</sup>
LEVEL 1	2012.427 m <sup>2</sup>
LEVEL 2	2022.794 m <sup>2</sup>
	6397.908 m <sup>2</sup>

OVERALL BUILDING FOOTPRINT AREA	
LEVEL	AREA
GROUND FLOOR	1777.337 m <sup>2</sup>
LEVEL 1	2147.632 m <sup>2</sup>
LEVEL 2	2146.405 m <sup>2</sup>
LOWER GROUND	779.971 m <sup>2</sup>
	6851.344 m <sup>2</sup>

BEDROOM TYPE SCHEDULE		
ROOM TYPE	LEVEL	No.
SINGLE BEDROOM	GROUND FLOOR	32
COMPANION BEDROOM	LEVEL 1	4
SINGLE BEDROOM	LEVEL 1	40
COMPANION BEDROOM	LEVEL 2	4
SINGLE BEDROOM	LEVEL 2	40
		TOTAL = 128 BEDS

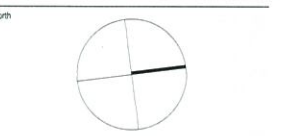

4	REVISED DA SUBMISSION	13.11.14	RP	SP
3	CLIENT REVIEW	12.11.14	RP	SP
2	ISSUE FOR DA	20.08.14	JC	JH
1	ISSUE FOR DA	12.08.14	RP	JH
Issue Description		Date	Chk	Auth
Architect				
dwpsutlers				
www.dwpsutlers.com				
Project				

OPAL HILLSIDE - LAKE MACQUARIE

Location

3 Violet Town Road, Mount Hutton NSW 2290, Australia

Client



Drawing

SITE PLAN - NEW WORKS

Scale

As indicated @ A1

Date Printed

13/11/2014 10:44:29 AM

Project Number

502779

Drawing Number

DA101

Issue


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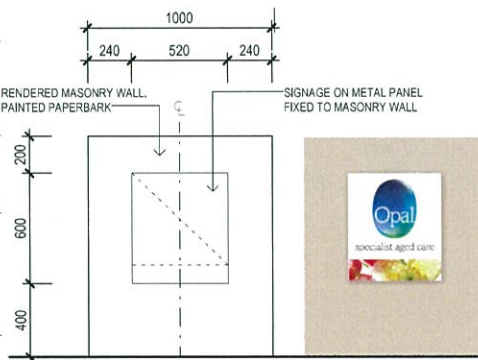
dwpsutlers



TYPICAL LANDSCAPE SIGNAGE - ON WALL




S1  
TYPICAL WALL SIGNAGE - REFER TO SITE PLAN FOR WALL CONFIGURATION

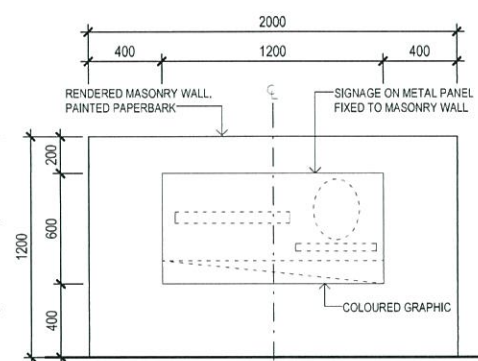

S1a  
TYPICAL WALL SIGNAGE - REFER TO SITE PLAN FOR WALL CONFIGURATION




TYPICAL DIRECTIONAL SIGNAGE - ON SITE

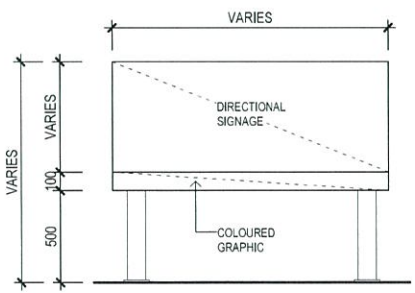

S2  
TYPICAL DIRECTIONAL SIGNAGE - ON SITE


FINAL LOCATIONS T.B.C

2  
TYPICAL SIGNAGE  
1:20

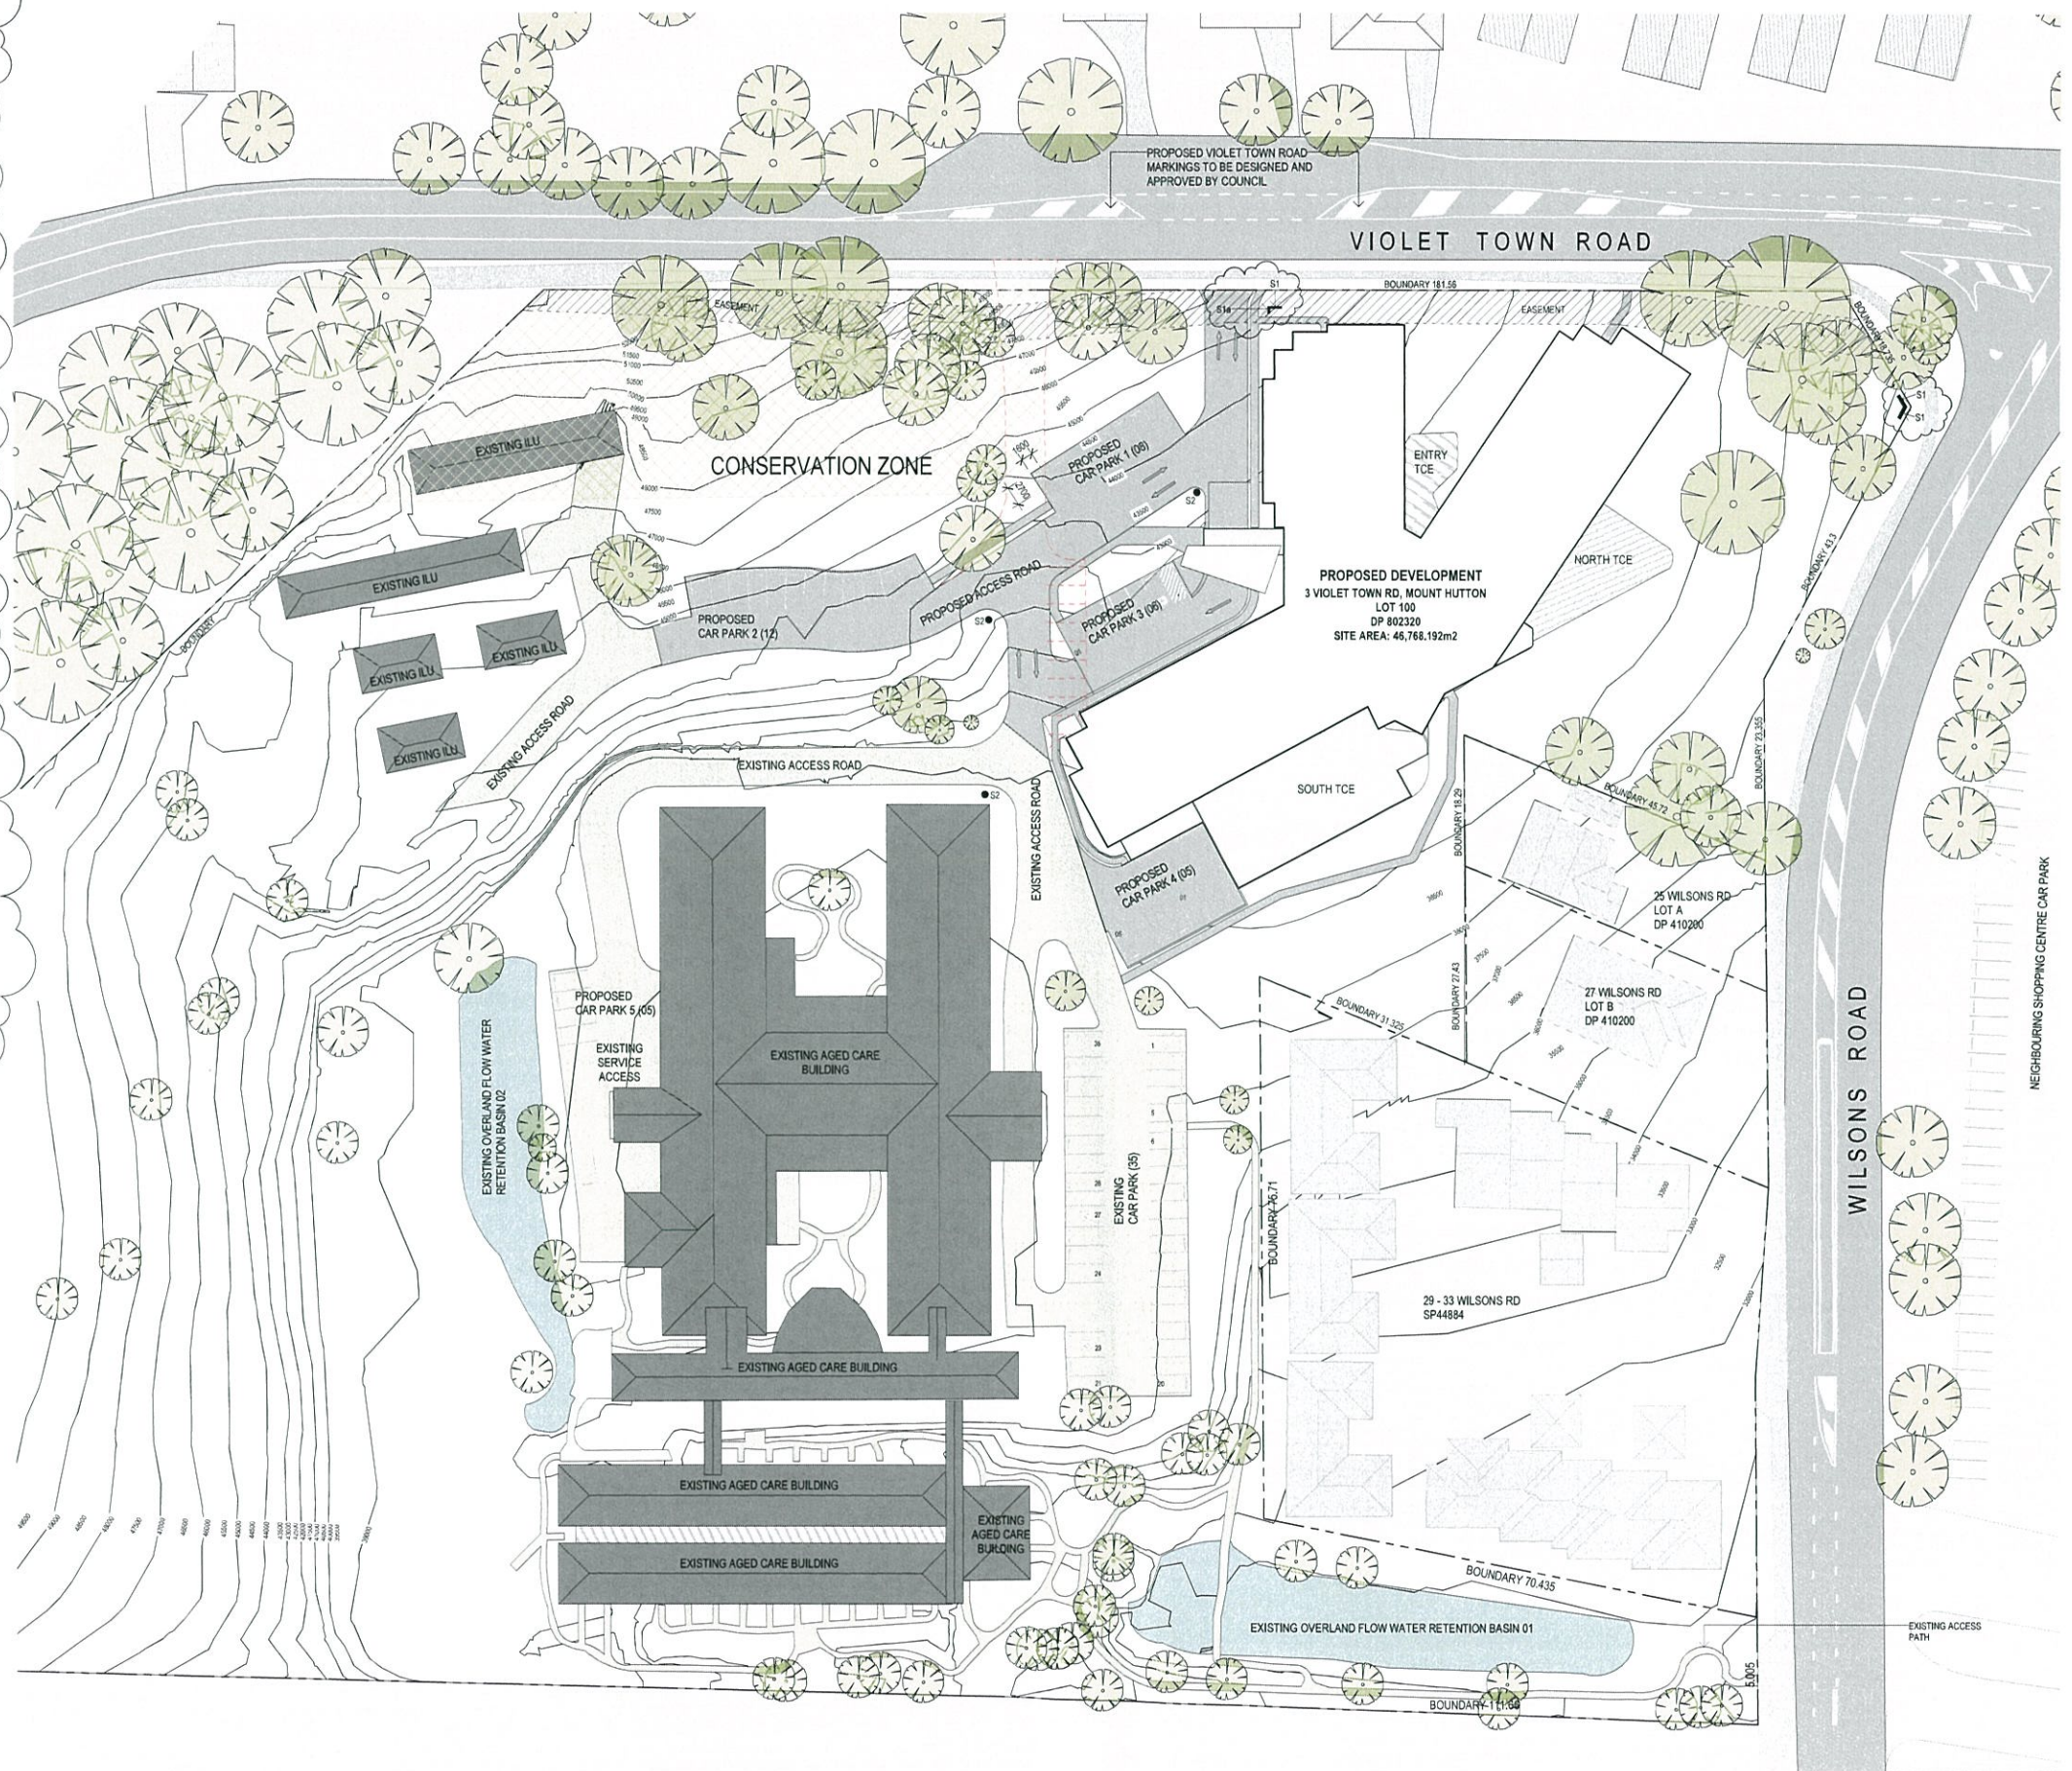


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100 SITE PLAN  
DA101 1:500




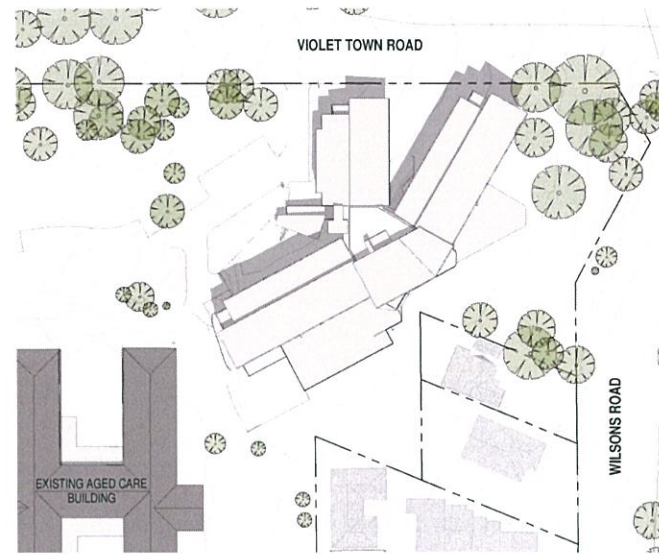


2 SHADOW DIAGRAM DEC 9AM  
DA401/ 1:1000

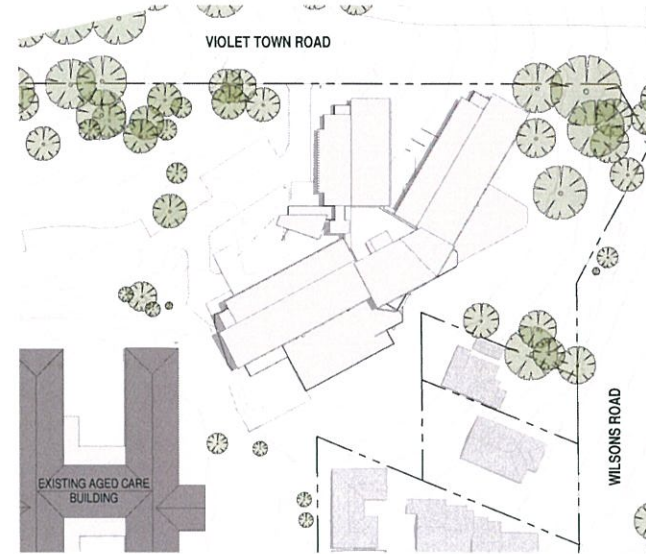


3 SHADOW DIAGRAM DEC 12PM  
DA401/ 1:1000

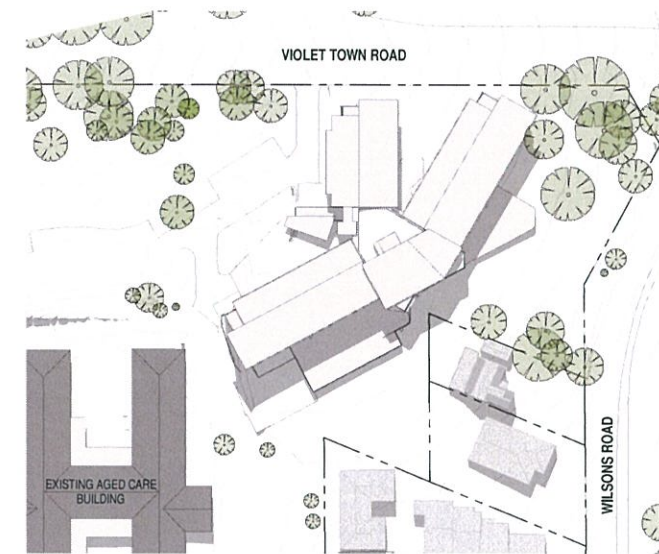


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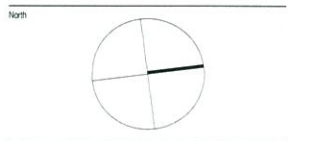
4 SHADOW DIAGRAM JUN 9AM  
DA401/ 1:1000

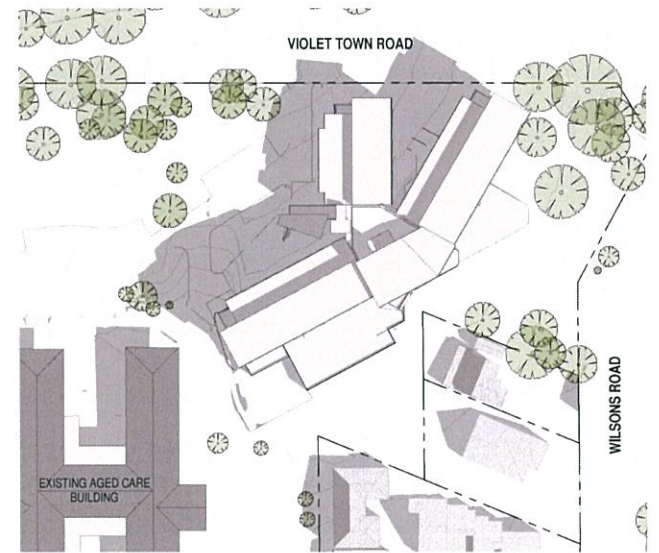

5 SHADOW DIAGRAM JUN 12PM  
DA401/ 1:1000

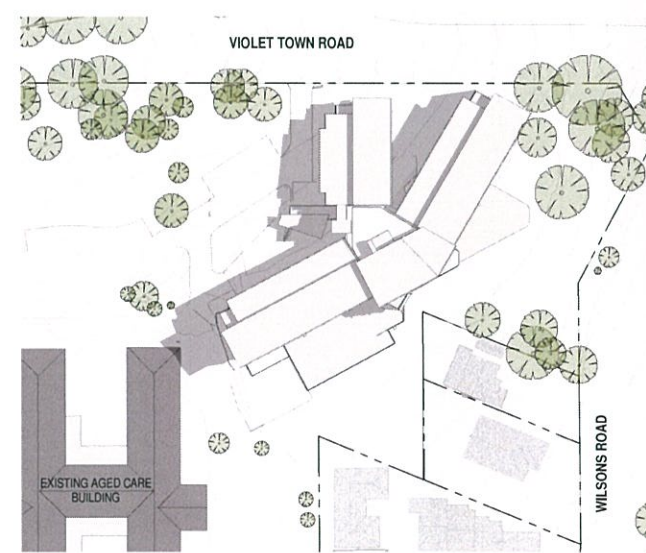

6 SHADOW DIAGRAM JUN 3PM  
DA401/ 1:1000

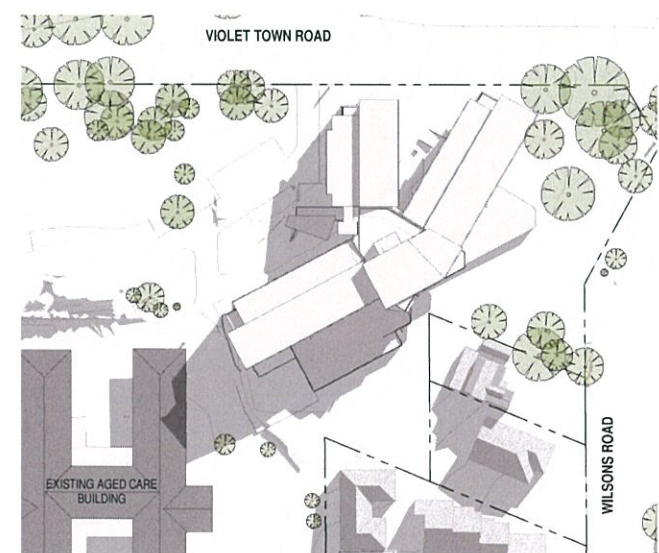


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Issue Description Date Chk Auth  
Architect  
dwp[suters]  
www.dwpsuters.com  
Project  
OPAL HILLSIDE - LAKE MACQUARIE  
Location  
3 Violet Town Road, Mount Hutton NSW 2290, Australia  
Client



Drawing  
SHADOW DIAGRAMS  
Scale Date Printed  
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Project Number Drawing Number Issue  
502779 DA161 1





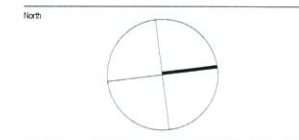

2	ISSUE FOR DA	20/08/14	JC	JH
1	ISSUE FOR DA	12/08/14	RP	JH
Issue Description		Date	CHK	Auth
Architect				
dwp suters				
www.dwpsuters.com				
Project				

OPAL HILLSIDE - LAKE MACQUARIE

Location

3 Violet Town Road, Mount Hutton NSW 2290, Australia

Client



Drawing


ROOF PLAN

Scale Date Printed


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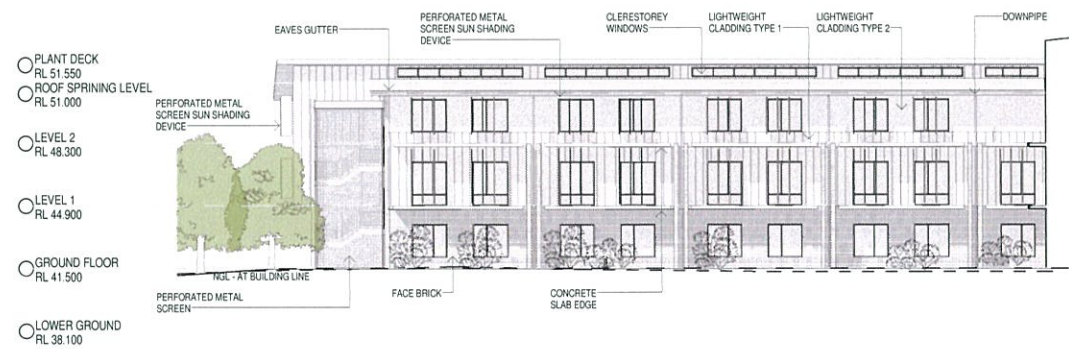
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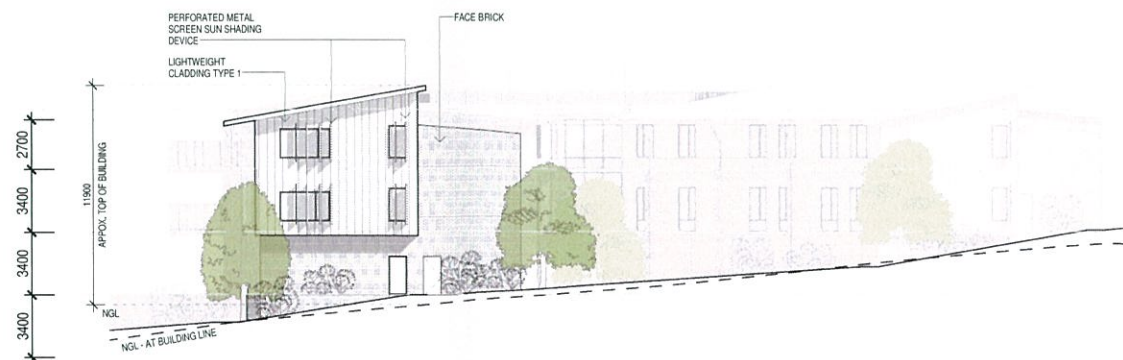




1 400\_NORTH WING\_EAST ELEVATION  
1:200

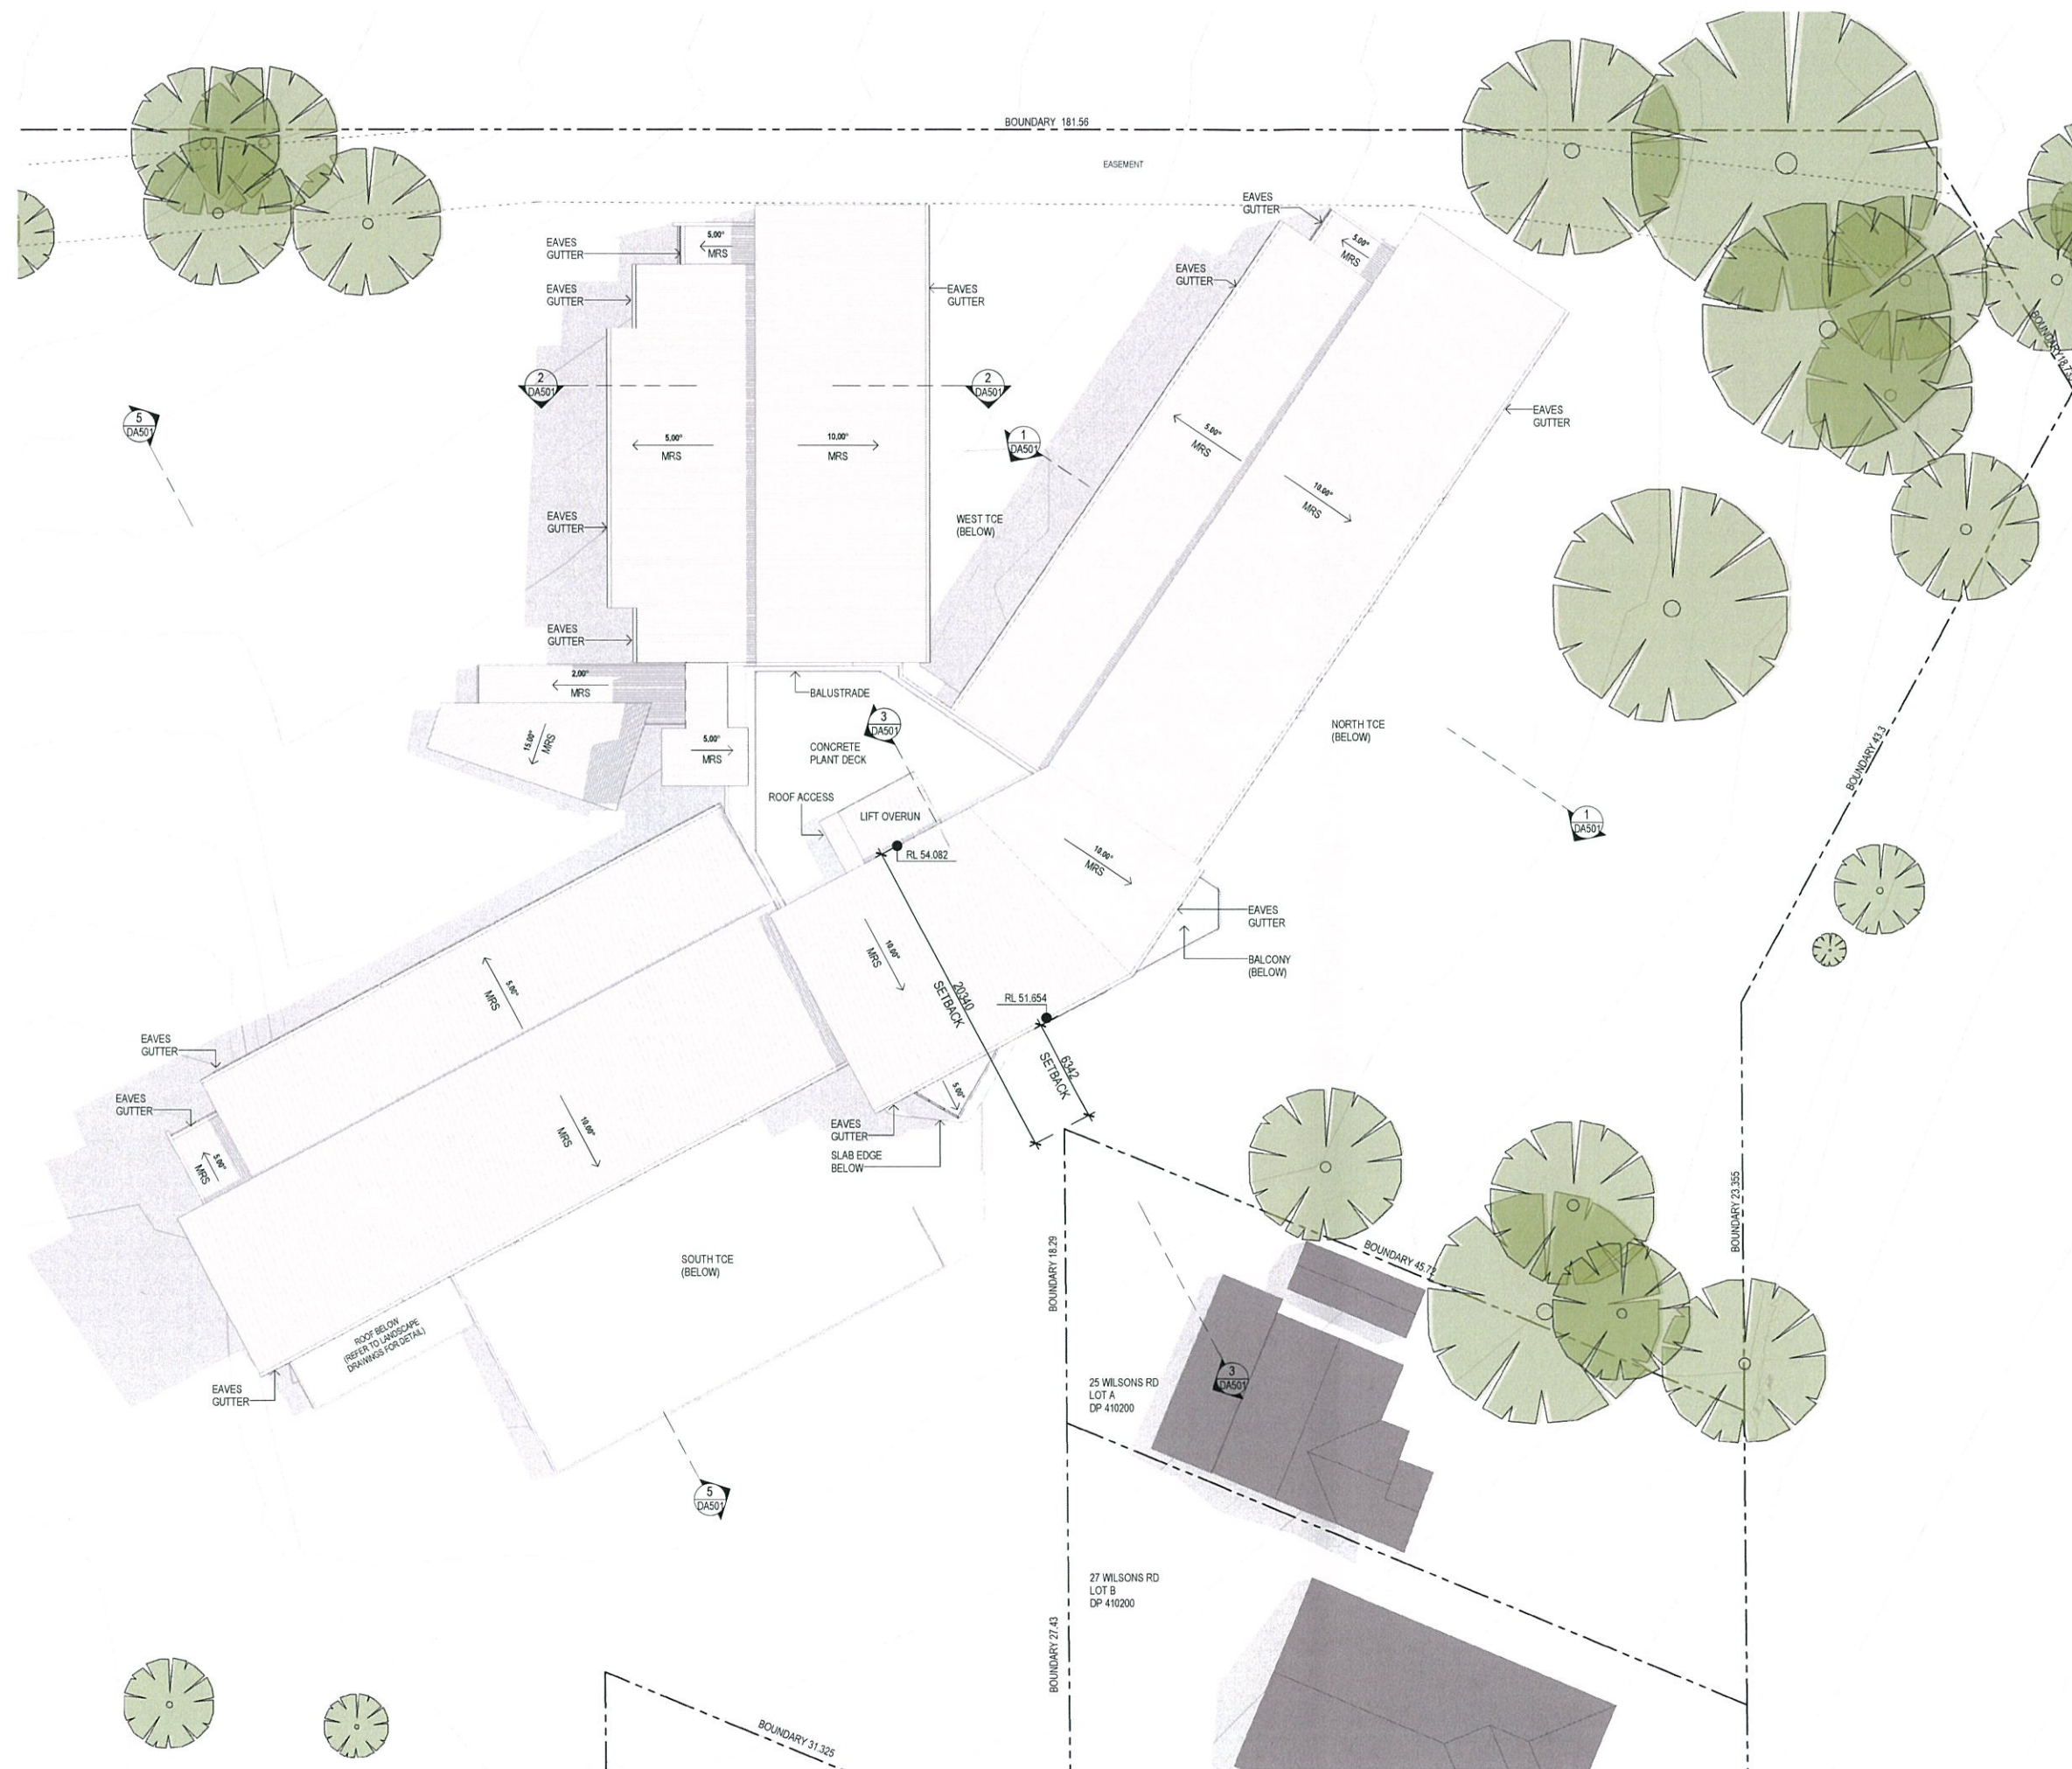

2 400\_NORTH WING\_SOUTH ELEVATION  
1:200

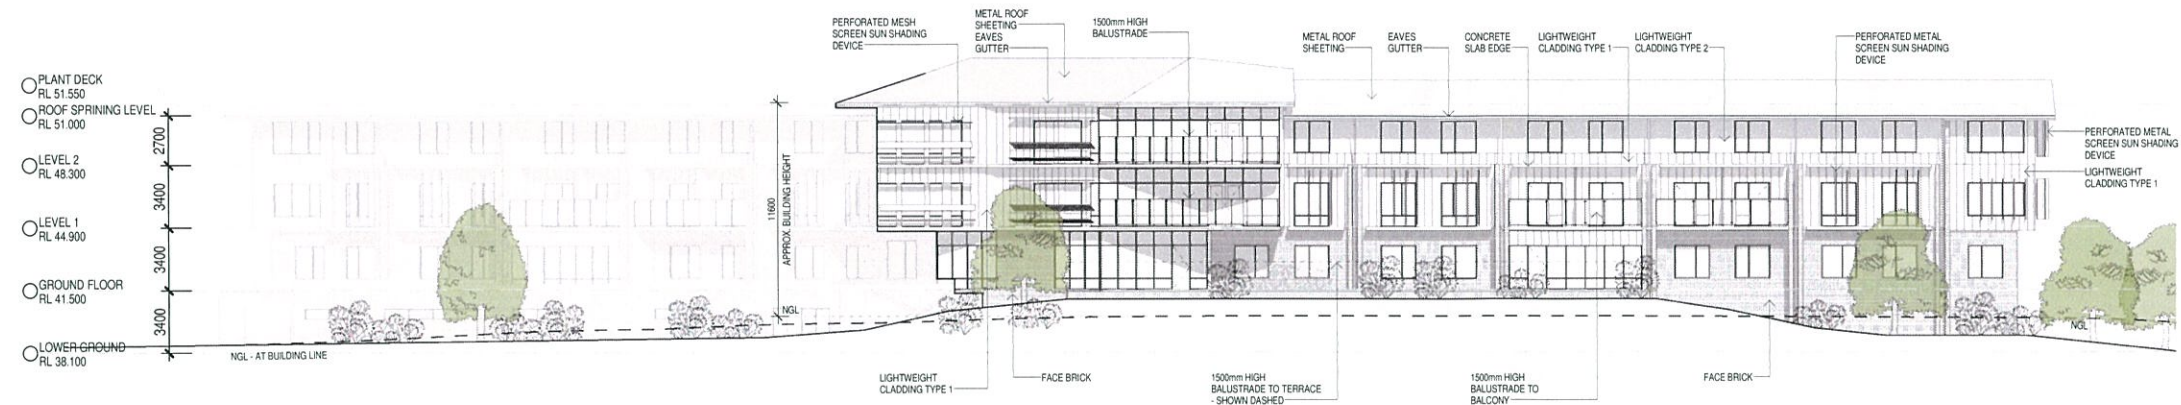

3 400\_NORTH WING\_WEST ELEVATION  
1:200

NOTE:  
LANDSCAPING SHOWN IS INDICATIVE  
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1	ISSUE FOR DA	12.08.14	RP	JH
Issue	Description	Date	Chk	Auth
Architect	dwp suters			
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Project	OPAL HILLSIDE - LAKE MACQUARIE			
Location	3 Violet Town Road, Mount Hutton NSW 2290, Australia			
Client				




Drawing	ELEVATIONS NORTH WING			
Scale	As indicated @ A1	Date Printed	13/08/2014 4:34:59 PM	Issue
Project Number	502779	Drawing Number	DA401	1





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Architect  
dwp/suters  
www.dwpsuters.com  
Project  
OPAL HILLSIDE - LAKE MACQUARIE  
Location  
3 Violet Town Road, Mount Hutton NSW 2250, Australia  
Client

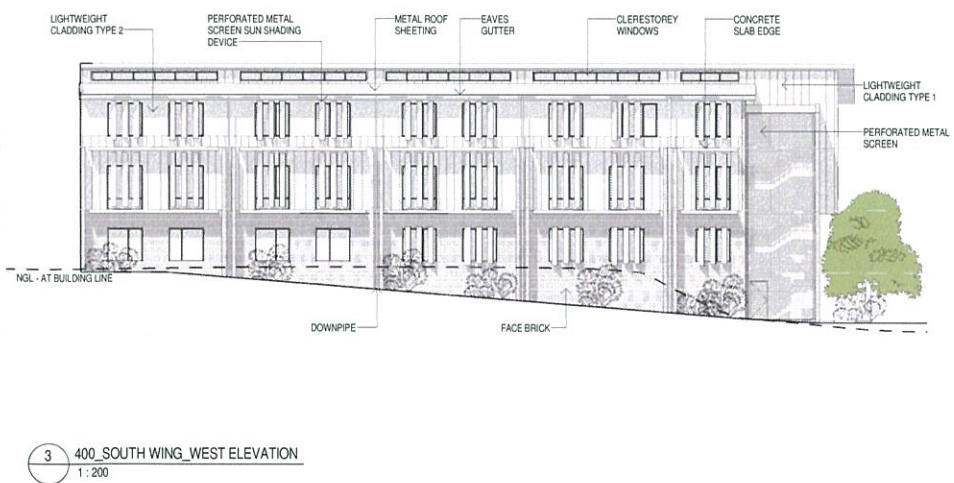


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ELEVATIONS SOUTH WING  
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Project Number 502779 Drawing Number DA402 Issue 1



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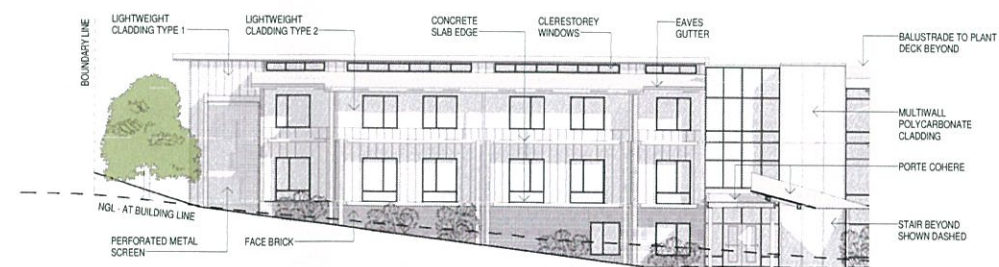
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1 400\_WEST WING\_WEST ELEVATION  
1:200



2 400\_WEST WING\_NORTH ELEVATION  
1:200

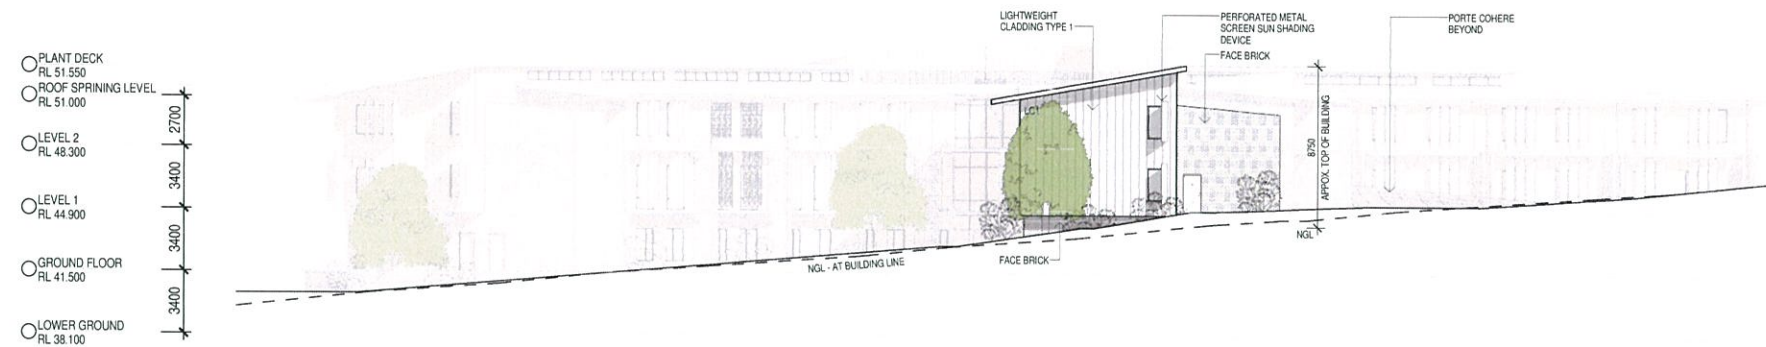

3 400\_WEST WING\_SOUTH ELEVATION  
1:200

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1	ISSUE FOR DA	12/08/14	FP	JH
Issue	Description	Date	Chk	Aut
Architect	dwp suters			
	www.dwpsuters.com			
Project	OPAL HILLSIDE - LAKE MACQUARIE			
Location	3 Violet Town Road, Mount Hutton NSW 2230, Australia			
Client	Opal specialist aged care			
Drawing	ELEVATIONS WEST WING			
Scale	As indicated @ A1	Date Printed	13/08/2014 4:36:28 PM	
Project Number	502779	Drawing Number	DA403	Issue
				1



# OPAL HILLSIDE

## DEVELOPMENT APPLICATION SUBMISSION

### LANDSCAPE ARCHITECTURE

#### CONTENTS

LP000 Cover Sheet, Legend & Plant Schedule  
LP001 Sheet Setout  
LP002 Site Plan

LP101 Landscape Plan 01  
LP102 Landscape Plan 02  
LP103 Landscape Plan 03  
LP104 Landscape Plan 04


LP201 Landscape Detail Plan 01  
LP202 Landscape Detail Plan 02  
LP203 Landscape Detail Plan 03


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LP302 Landscape Sections 02  
LP303 Landscape Sections 03


LP401 Landscape Details 01  
LP402 Landscape Details 02


LP501 Supplementary Information 01  
LP502 Supplementary Information 02  
LP503 Supplementary Information 03


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
 Site Boundary


 Existing Trees to Remain  
Existing Tree Protection Zone  
Existing Tree Structural Root Zone  
- Refer Arborist report for details


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(29 no.)


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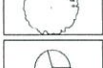
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TOW 49.20


 Open Palisade Fence + Gate


 Tactile Indicators  
TSGI

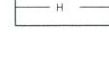
 Balustrade (1500 height)  
Handrail

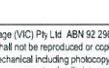
 Proposed Trees On Grade  
01 02  
401 401

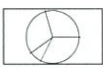
 Proposed Trees On Grade  
01 02  
401 401

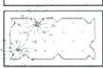
 Proposed Trees On Slab


 Proposed Mass Planting  
- On Grade  
01 02  
402 402

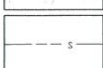
 Proposed Mass Planting  
- On Slab  
02 02  
402 402

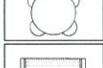
 Turf  
T


 Steel Edge  
03 03  
402 402

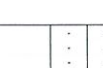
 Table and Chairs

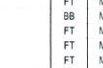
 Bench Seat

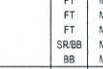
 Post top lighting  
LB


 Bollard lighting  
OB

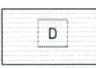
 Timber Deck  
D

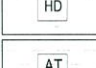
 Hydroseed  
HD


 Artificial Turf  
AT  
04 04  
402 402

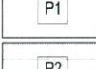
 Broom Finish Concrete  
BC

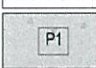
 Paving - Type 1  
On Grade  
P1  
05 05  
402 402

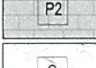
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On Grade  
P2  
06 06  
402 402

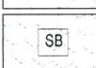
 Paving - Type 1  
On Slab  
P1  
07 07  
402 402


 Paving - Type 2  
On Slab  
P2  
08 08  
402 402


 Loose Gravel Path  
On Slab  
G  
09 09  
402 402


 Stone Ballast  
On slab  
SB  
10 10  
402 402

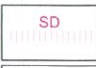 Subsoil Drainage  
- connect to RWO  
SD

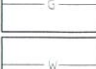 Service Gas  
G

 Service Water  
W

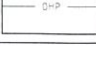 Telstra  
T

 Power  
P

#### INDICATIVE PLANT SCHEDULE

INDICATIVE PLANT SCHEDULE				
Botanical Name	Common Name	Pot Size	Size @ Maturity (H x W)	Spacing
TREES				
<i>Angophora costata</i>	Smooth Barked Apple	45L	25.0 x 15.0m	As shown
<i>Eucalyptus gummifera</i>	Red Bloodwood	45L	20.0 x 10.0m	As shown
<i>Eleocarpus reticulatis</i>	Blueberry Ash	75L	12.0 x 8.0m	As shown
<i>Eucalyptus eugenioides</i>	Thin Leaved Stringybark	45L	15.0 x 10.0m	As shown
<i>Eucalyptus punctata</i>	Grey Gum	45L	20.0 x 10.0m	As shown
<i>Lagerstroemia indica</i>	Crepe Myrtle	75L	8.0 x 6.0m	As shown
<i>Magnolia grandiflora</i> 'Exmouth'	Magnolia	75L	8.0 x 6.0m	As shown
<i>Plumeria obtusa</i>	Frangipani	75L	8.0 x 6.0m	As shown
<i>Robinia pseudoacacia</i> 'Frisia'	Black Locust	75L	10.0 x 8.0m	As shown
<i>Tristanopsis laurina</i>	Water Gum	45L	10.0 x 8.0m	As shown
<i>Ulmus parvifolium</i>	Chinese Elm	75L	12.0 x 8.0m	As shown

MASS PLANTING				
<i>Camellia sasanqua</i>	Small Leaf Camellia	45L	3.5 x 3.0m	2/m2
<i>Gardenia augusta</i> 'Florida'	Gardenia	200mm	1.0 x 1.0m	2/m2
<i>Murraya paniculata</i>	Orange Jasmine	300mm	4.0 x 3.0m	2/m2
<i>Pittosporum tenuifolium</i>	Green Pillar Pittosporum	300mm	5.0 x 3.0m	2/m2

CLIMBERS + GROUNDCOVERS				
<i>Dianella caerulea</i>	Blue Flax Lily	150mm	1.0 x 0.6m	4/m2
<i>Liriope muscari</i>	Blue Lily Turf	150mm	0.5 x 0.5m	4/m2
<i>Trachelospermum jasminoides</i>	Star Jasmine	200mm	6.0 x 1.2m	4/m2
<i>Poa labillardieri</i> 'Eskdale'	Common Tussock Grass	tube	0.7 x 0.5m	4/m2
<i>Clivia miniata</i>	Natal Lily	200mm	0.5 x 0.5m	4/m2
<i>Lomandra longifolia</i> 'Tanika'	Tanika Mat Rush	200mm	0.5 x 0.5m	4/m2
<i>Lomandra longifolia</i>	Spiny Head Mat Rush	200mm	0.7 x 0.5m	4/m2
<i>Myoporum parvifolium</i>	Creeping Boobialla	150mm	0.2 x 1.0m	4/m2
<i>Agave attenuata</i>	Century Plant	200mm	0.7 x 0.5m	4/m2

CONSERVATION ZONE PLANT LIST				
TREES				
<i>Eucalyptus gummifera</i>	Red Bloodwood	45L	20.0 x 10.0m	As shown
<i>Eucalyptus maculata</i>	Spotted Gum	45L	20.0 x 10.0m	As shown
<i>Eucalyptus robusta</i>	Swamp Mahogany	45L	20.0 x 10.0m	As shown
MASS PLANTING				
<i>Lomandra longifolia</i>	Spiny Head Mat Rush	150mm	0.7 x 0.5m	4/m2
<i>Dianella revoluta</i>	Blue Flax-lily	150mm	0.7 x 0.5m	4/m2
<i>Doryanthes excelsa</i>	Gymea Lily	300mm	2.0 x 1.0m	2/m2

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The contractor shall check and verify all work on site (including work by others) before commencing the landscape installation. Any discrepancies are to be reported to the Project Manager or Landscape Architect prior to commencing work. Do not scale this drawing. Any required dimensions not shown shall be referred to the Landscape Architect for confirmation.

Issue	Revision	Description	Drawn	Check	Date
K	DA SUBMISSION - PLANS ADDED	FT	MP		19.12.2014
J	DA SUBMISSION - PLANS ADDED	BB	MP		10.11.2014
I	T13 REMOVED	FT	MP		18.08.2014
H	DA SUBMISSION	FT	MP		08.08.2014
G	T15 & T16 ALREADY REMOVED	FT	MP		06.08.2014
F	FOR REVIEW	FT	MP		01.08.2014
E	MINOR AMENDMENT	MP	MP		22.07.2014
D	FOR REVIEW	FT	MP		15.07.2014
C	FOR REVIEW	FT	MP		14.07.2014
B	PRE-DA MEETING 29.05.2014	SR/BB	MP		26.05.2014
A	FOR REVIEW	BB	MP		23.05.2014

Landscape Architects		478 William Street West Melbourne VIC 3003 Australia		Tel: (61 3) 629 4633 Web: www.siteimage.com.au Site Image (VIC) Pty Ltd ABN 92 298 551 413	
Client:		OPAL AGED CARE		Drawing Name: COVER SHEET, LEGEND & PLANT SCHEDULE	
Project:		OPAL HILLSIDE VIOLET TOWN RD MOUNT HUTTON		DA SUBMISSION	
Job Number:		SM14147		Drawing Number: LP000	
Issue:		K		K	

















LP402 B





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Issue	Reviser Description	FT	MP	Days
A	DA SUBMISSION			18/12/2014
		Drawn	Check	Days

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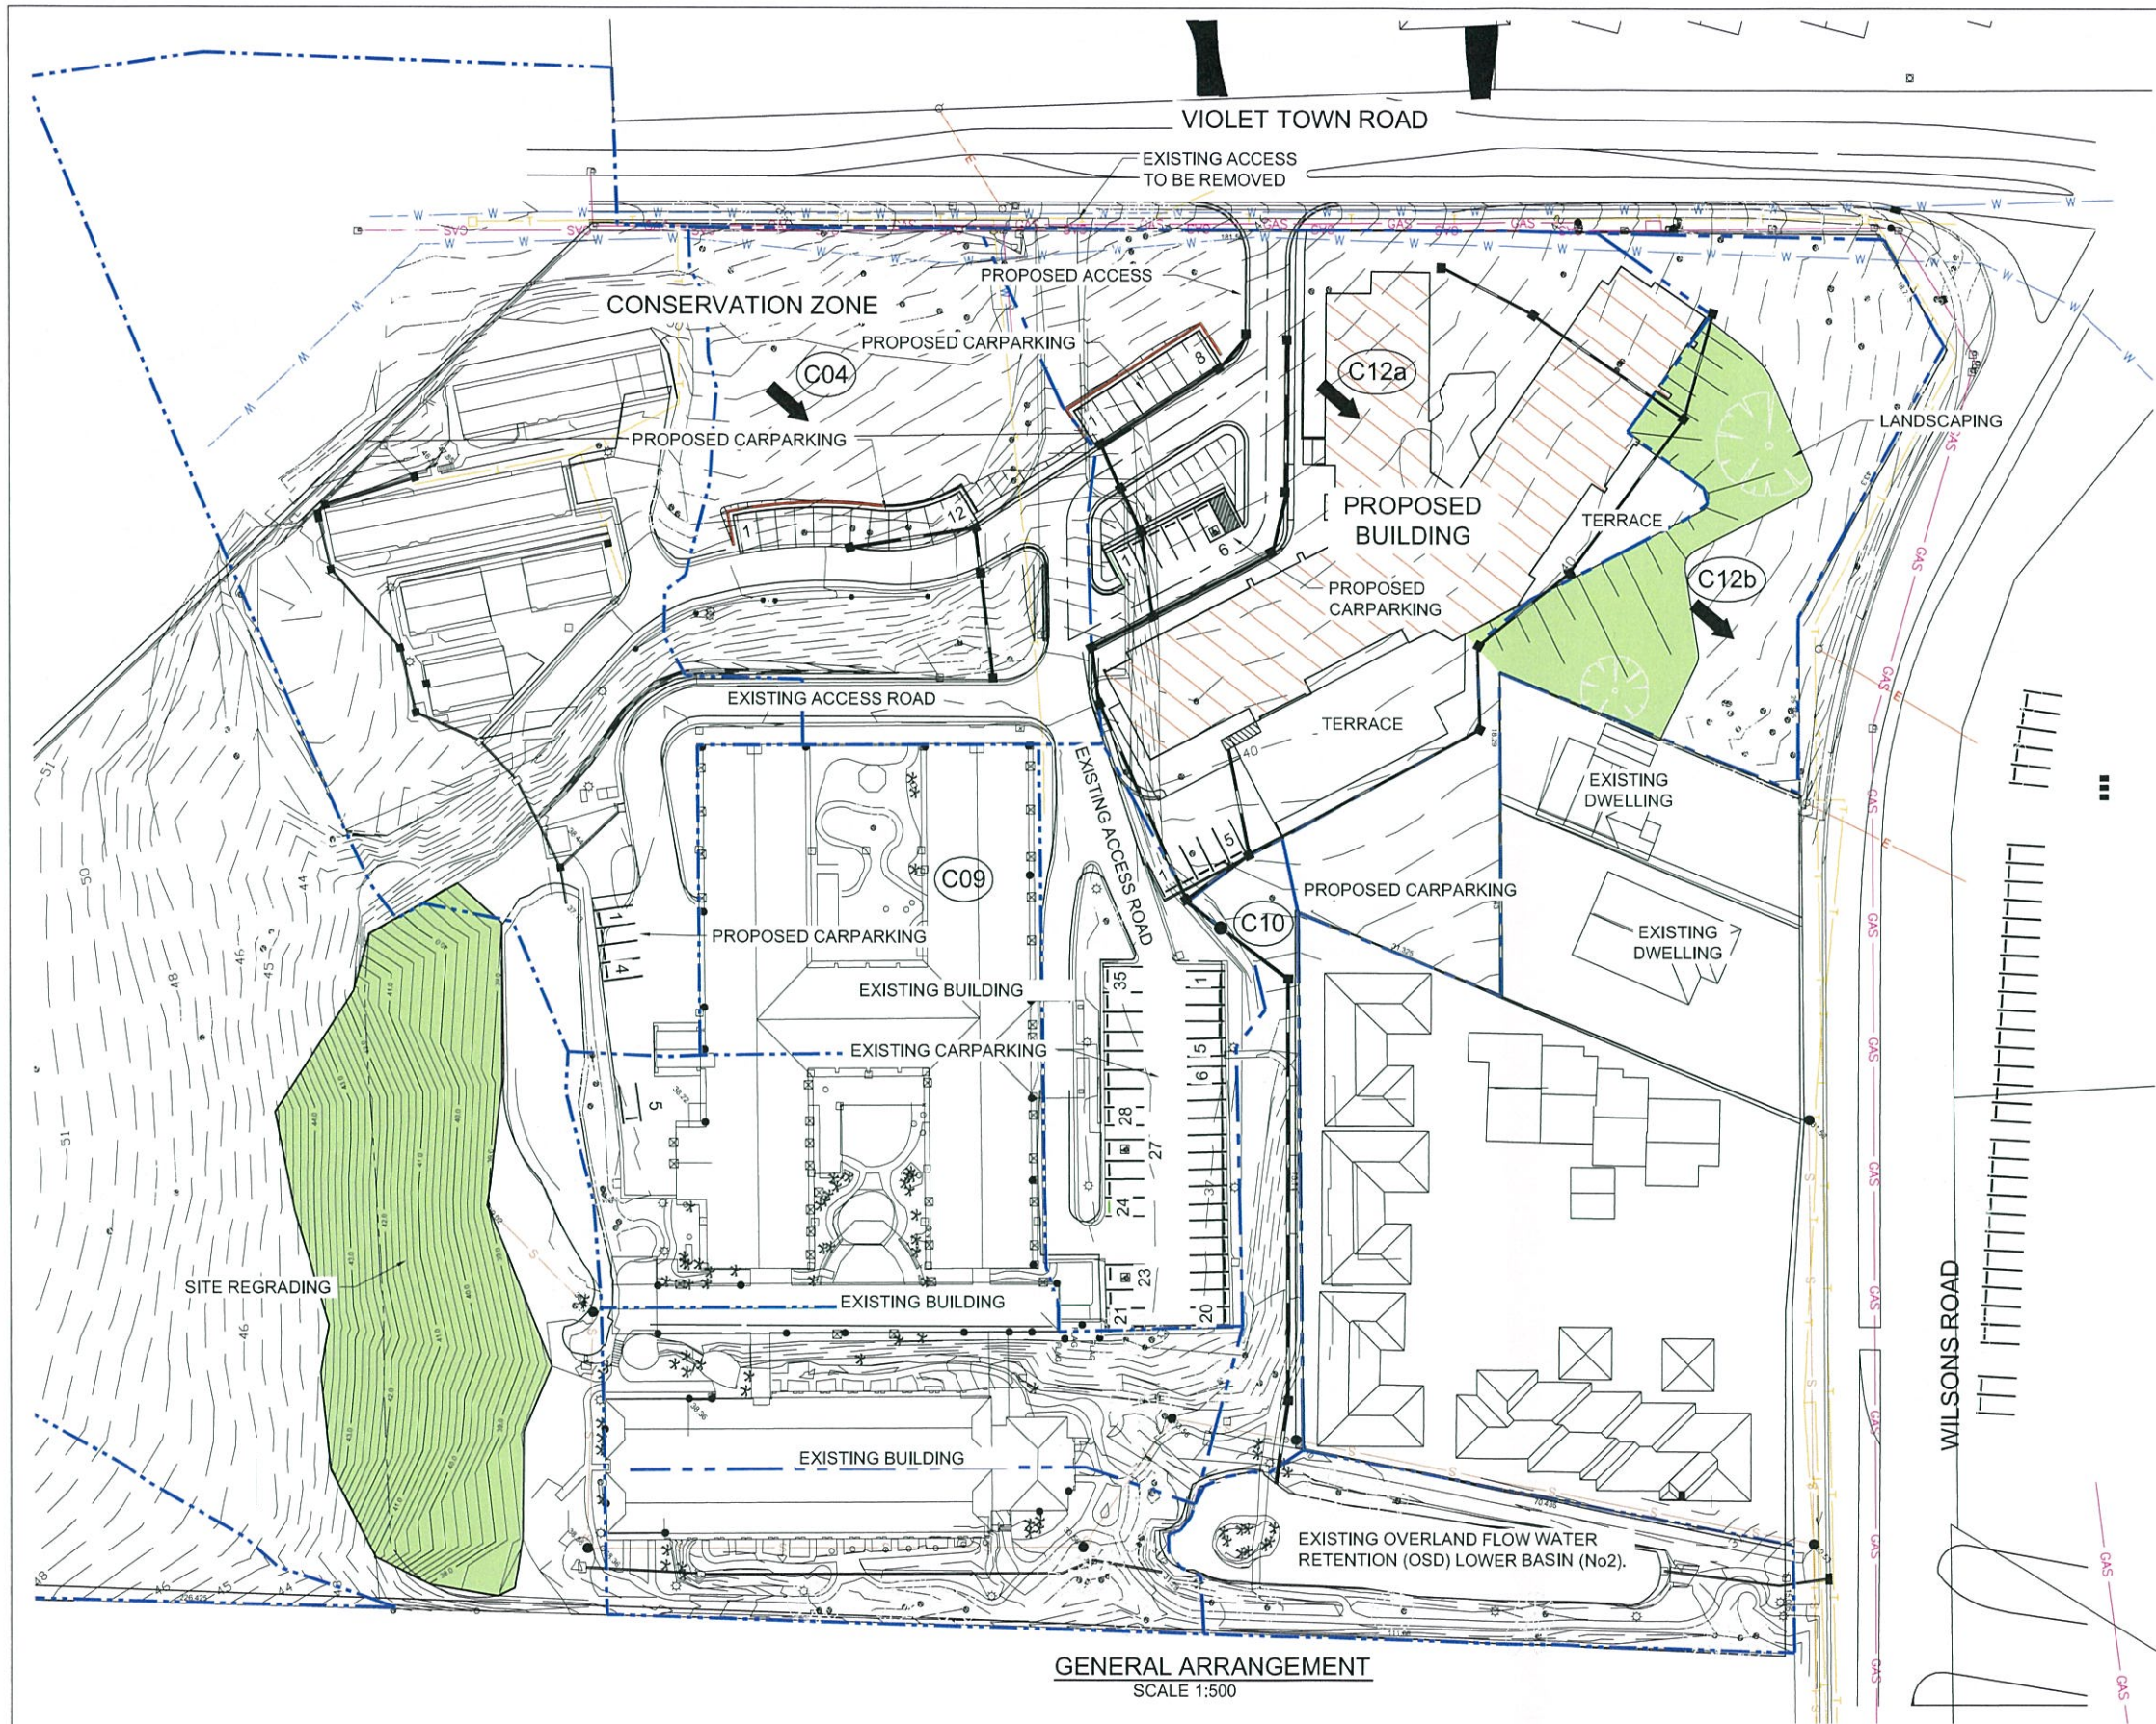


Project:  
OPAL HILLSIDE  
VIOLET TOWN RD  
MOUNT HUTTON

DA SUBMISSION

Scale: N/A		
Job Number: SM14147	Drawing Number: LP503	Issue: A





### NOTES

- ALL STORMWATER TO BE IN ACCORDANCE WITH AS3500.3 AND LAKE MACQUARIE COUNCIL REQUIREMENTS .
- FOR DETAILS OF ASSESSMENT OF THE STORMWATER MANAGEMENT FOR THIS PROPOSED DEVELOPMENT REFER TO THE 'STORMWATER MANAGEMENT PLAN' SUMMARY REPORT DATED 24.07.2014. A SUMMARY OF THE KEY INFORMATION IS SHOWN ON IN THE TABLES BELOW.

Summary of Stormwater / OSD design			
As per DRAIN models (Hillside Pre-Dev 2014 DA Model.drn and Hillside Post-Dev 2014 DA model.drn)			
	Pre-development	Post-Development	
Catchment Area (ha)	6.567	6.567	
Site runoff (cu. m/s) for 100yr ARI			
Lower Basin - piped	0.627	0.592	
Lower Basin - overland	0.543	0.664	
Catchment 12	0.353	0.151 post development 12(b)	
Site Worst case Peaks Total	1.523	1.407 < existing therefore okay (20yr and 5yr ARI similar)	
Peak Hydrograph at outlet			
100yr ARI	1.40	1.36 < existing therefore okay	
20yr ARI	1.06	1.00 < existing therefore okay	
5 yr ARI	0.79	0.67 < existing therefore okay	
OSD storage			
Existing Basin 1 (cu. m)	472	472	
Existing Basin 2 (cu. m)	339	490 lower permanent water level by 0.2m (151cu.m)	
	811	962	
Site changes			
Additional Impervious areas (ha)		0.53	
Additional OSD storage (cu. m)		151 lower basin	

Revised 2014 DA catchment summary											
Pre Development						Post-Development					
Catchment	Catchment Name	Area	Fraction impervious	Fraction pervious		Area	Fraction impervious	Fraction pervious		Change in catchment area	Pre Post Increased
(Ref)		(ha)	%	%		(ha)	%	%		(ha)	(ha)
C01	South Eastern	0.538	0%	100%	0.538	0%	100%	0.000	0.000	0.000	0.000
C02	Southern	2.564	3%	97%	2.564	3%	97%	0.000	0.077	0.077	0.000
C03	South Western	0.892	30%	70%	0.892	30%	70%	0.000	0.268	0.268	0.000
C04	Western	0.440	28%	72%	0.427	42%	58%	-0.013	0.123	0.179	0.056
C05	Central 1	0.203	83%	17%	0.203	83%	17%	0.000	0.169	0.169	0.000
C06	Central 2	0.240	77%	23%	0.240	77%	23%	0.000	0.185	0.185	0.000
C07	Central 3	0.189	57%	43%	0.189	57%	43%	0.000	0.108	0.108	0.000
C08	Eastern	0.175	47%	53%	0.175	47%	53%	0.000	0.062	0.062	0.000
C09	Northern 1	0.112	73%	27%	0.200	71%	29%	-0.012	0.155	0.143	-0.012
C10	Northern 2	0.147	7%	93%	0.078	13%	87%	-0.069	0.010	0.010	0.000
C11	North Eastern	0.178	8%	92%	0.178	8%	92%	0.000	0.014	0.014	0.000
C12a	North Western (dev.)	0.406	0%	100%	0.499	97%	3%	0.093	0.000	0.484	0.484
C12b	North Western (undev.)	0.383	0%	100%	0.383	0%	100%	0.000	0.000	0.000	0.000
		6.567	0%	100%	6.567	0%	100%	0.000	0.000	0.000	0.529

### LEGEND

- C01 CATCHMENT NODE
- SURFACE FALL
- CATCHMENT BOUNDARY

### NOTE

THIS STORMWATER MANAGEMENT PLAN HAS BEEN BASED ON THE ARCHITECTS DWP SUTERS PROPOSED DEVELOPMENT DRAWINGS No'S 502779 DA101H, 2012G, DA202J, DA203F, DA204F AND DA205B.

PRELIMINARY

Revision	Amendment	Approved	Revision Date
A	PRELIMINARY ISSUE	J.C.	22.05.14
B	PRE DA ISSUE	J.C.	27.05.14
C	PRE DA ISSUE	J.C.	30.06.14
D	CLIENT REVIEW	J.C.	15.07.14
E	DA REVIEW	J.C.	29.07.14
F	DA ISSUE	J.C.	08.08.14
G	REVISED DA ISSUE	J.C.	22.08.14
H	REVISED DA ISSUE	J.C.	12.11.14




Drawn	Designed	Approved	Revision Date
A. HYLAND	R. CHARLTON		22.05.2014
Project No.	Scale	Drawing No.	Sheet No.
T-N0280.00	1:500	T-N0280.00_DA1	H

HILLSIDE  
LAKE MACQUARIE  
AGED CARE FACILITY

ROADWORKS AND STORMWATER  
GENERAL ARRANGEMENT

1:500 @ A1  
1:1000 @ A3



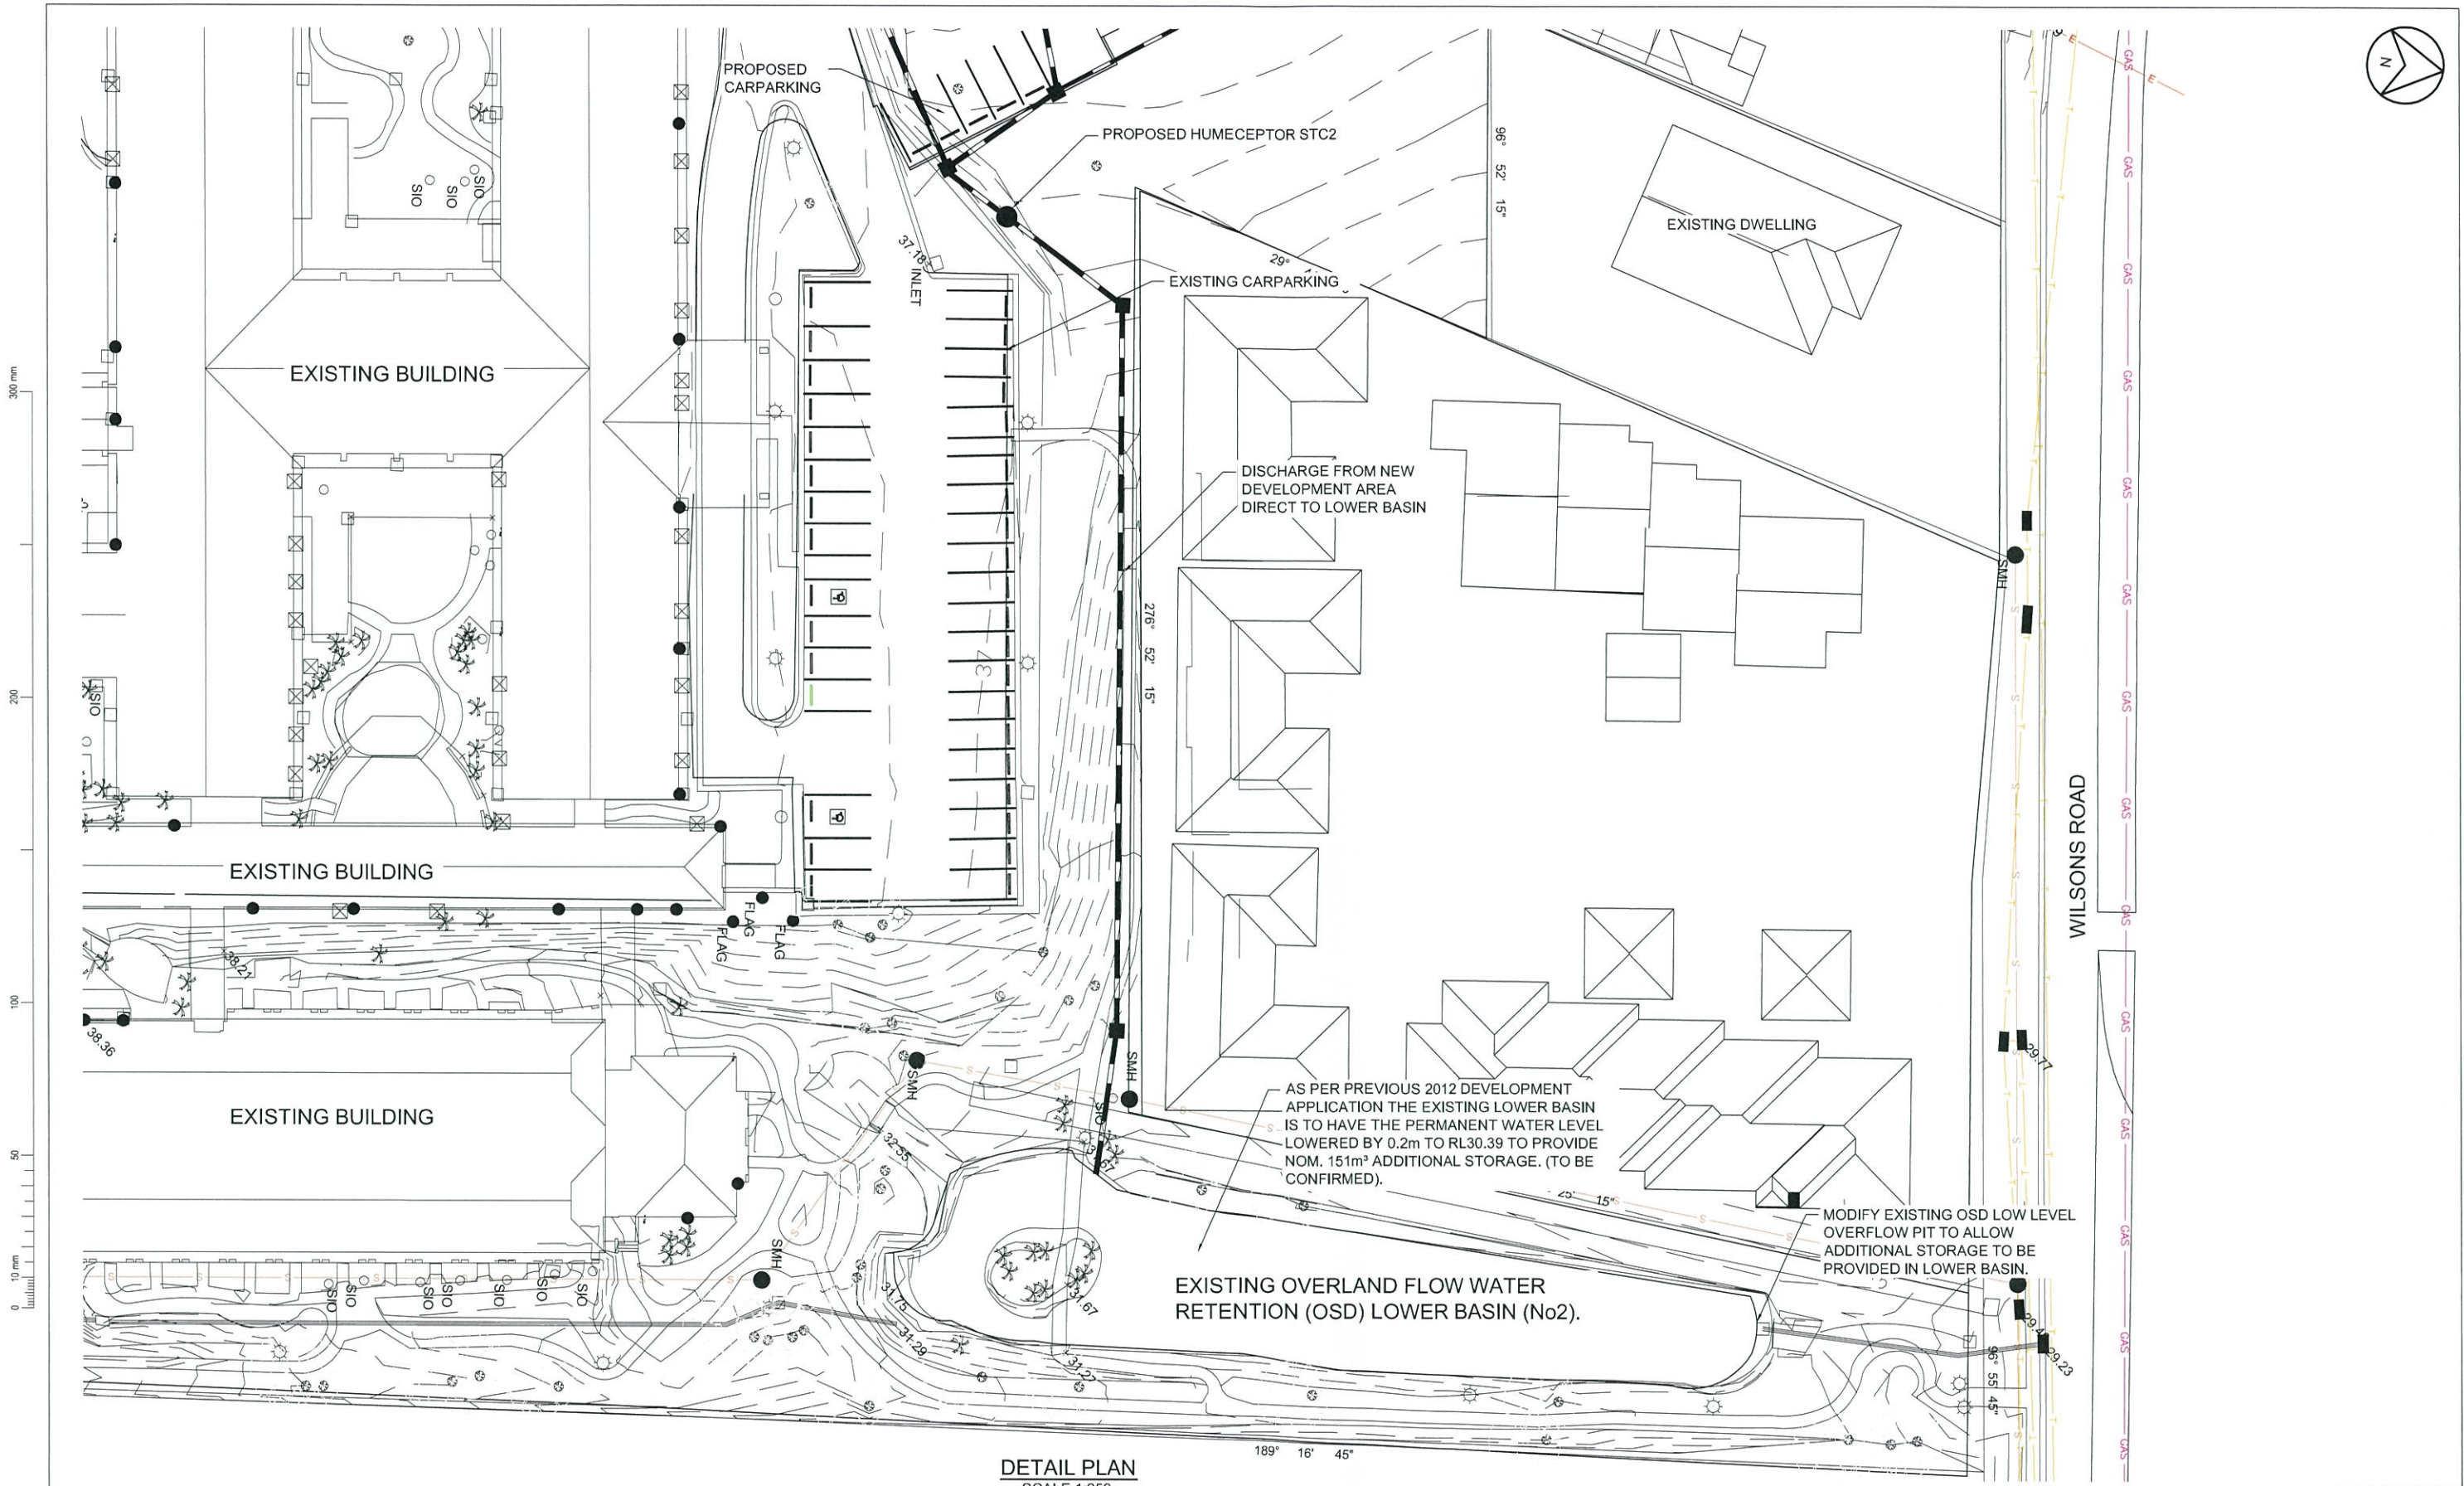

DETAIL PLAN  
SCALE 1:250

PRELIMINARY

Revision	Amendment	Approved	Revision Date
A	PRELIMINARY ISSUE	J.C.	22.05.14
B	PRE DA ISSUE	J.C.	27.05.14
C	PRE DA ISSUE	J.C.	30.06.14
D	CLIENT REVIEW	J.C.	15.07.14
E	DA REVIEW	J.C.	29.07.14
F	DA ISSUE	J.C.	08.08.14
G	REVISED DA ISSUE	J.C.	22.08.14
H	REVISED DA ISSUE	J.C.	12.11.14



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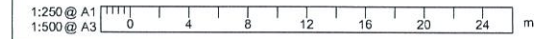
Project  
HILLSIDE  
LAKE MACQUARIE  
AGED CARE FACILITY

Sheet  
STORMWATER MANAGEMENT PLAN  
DETAIL PLAN 2

Drawn	Designed	Approved	Revision Date
A. HYLAND	R. CHARLTON		22.05.14

Project No.	Scale
T-N0280.00	1:250


Drawing No.	Sheet No.	Revision
T-N0280.00_DA3		H









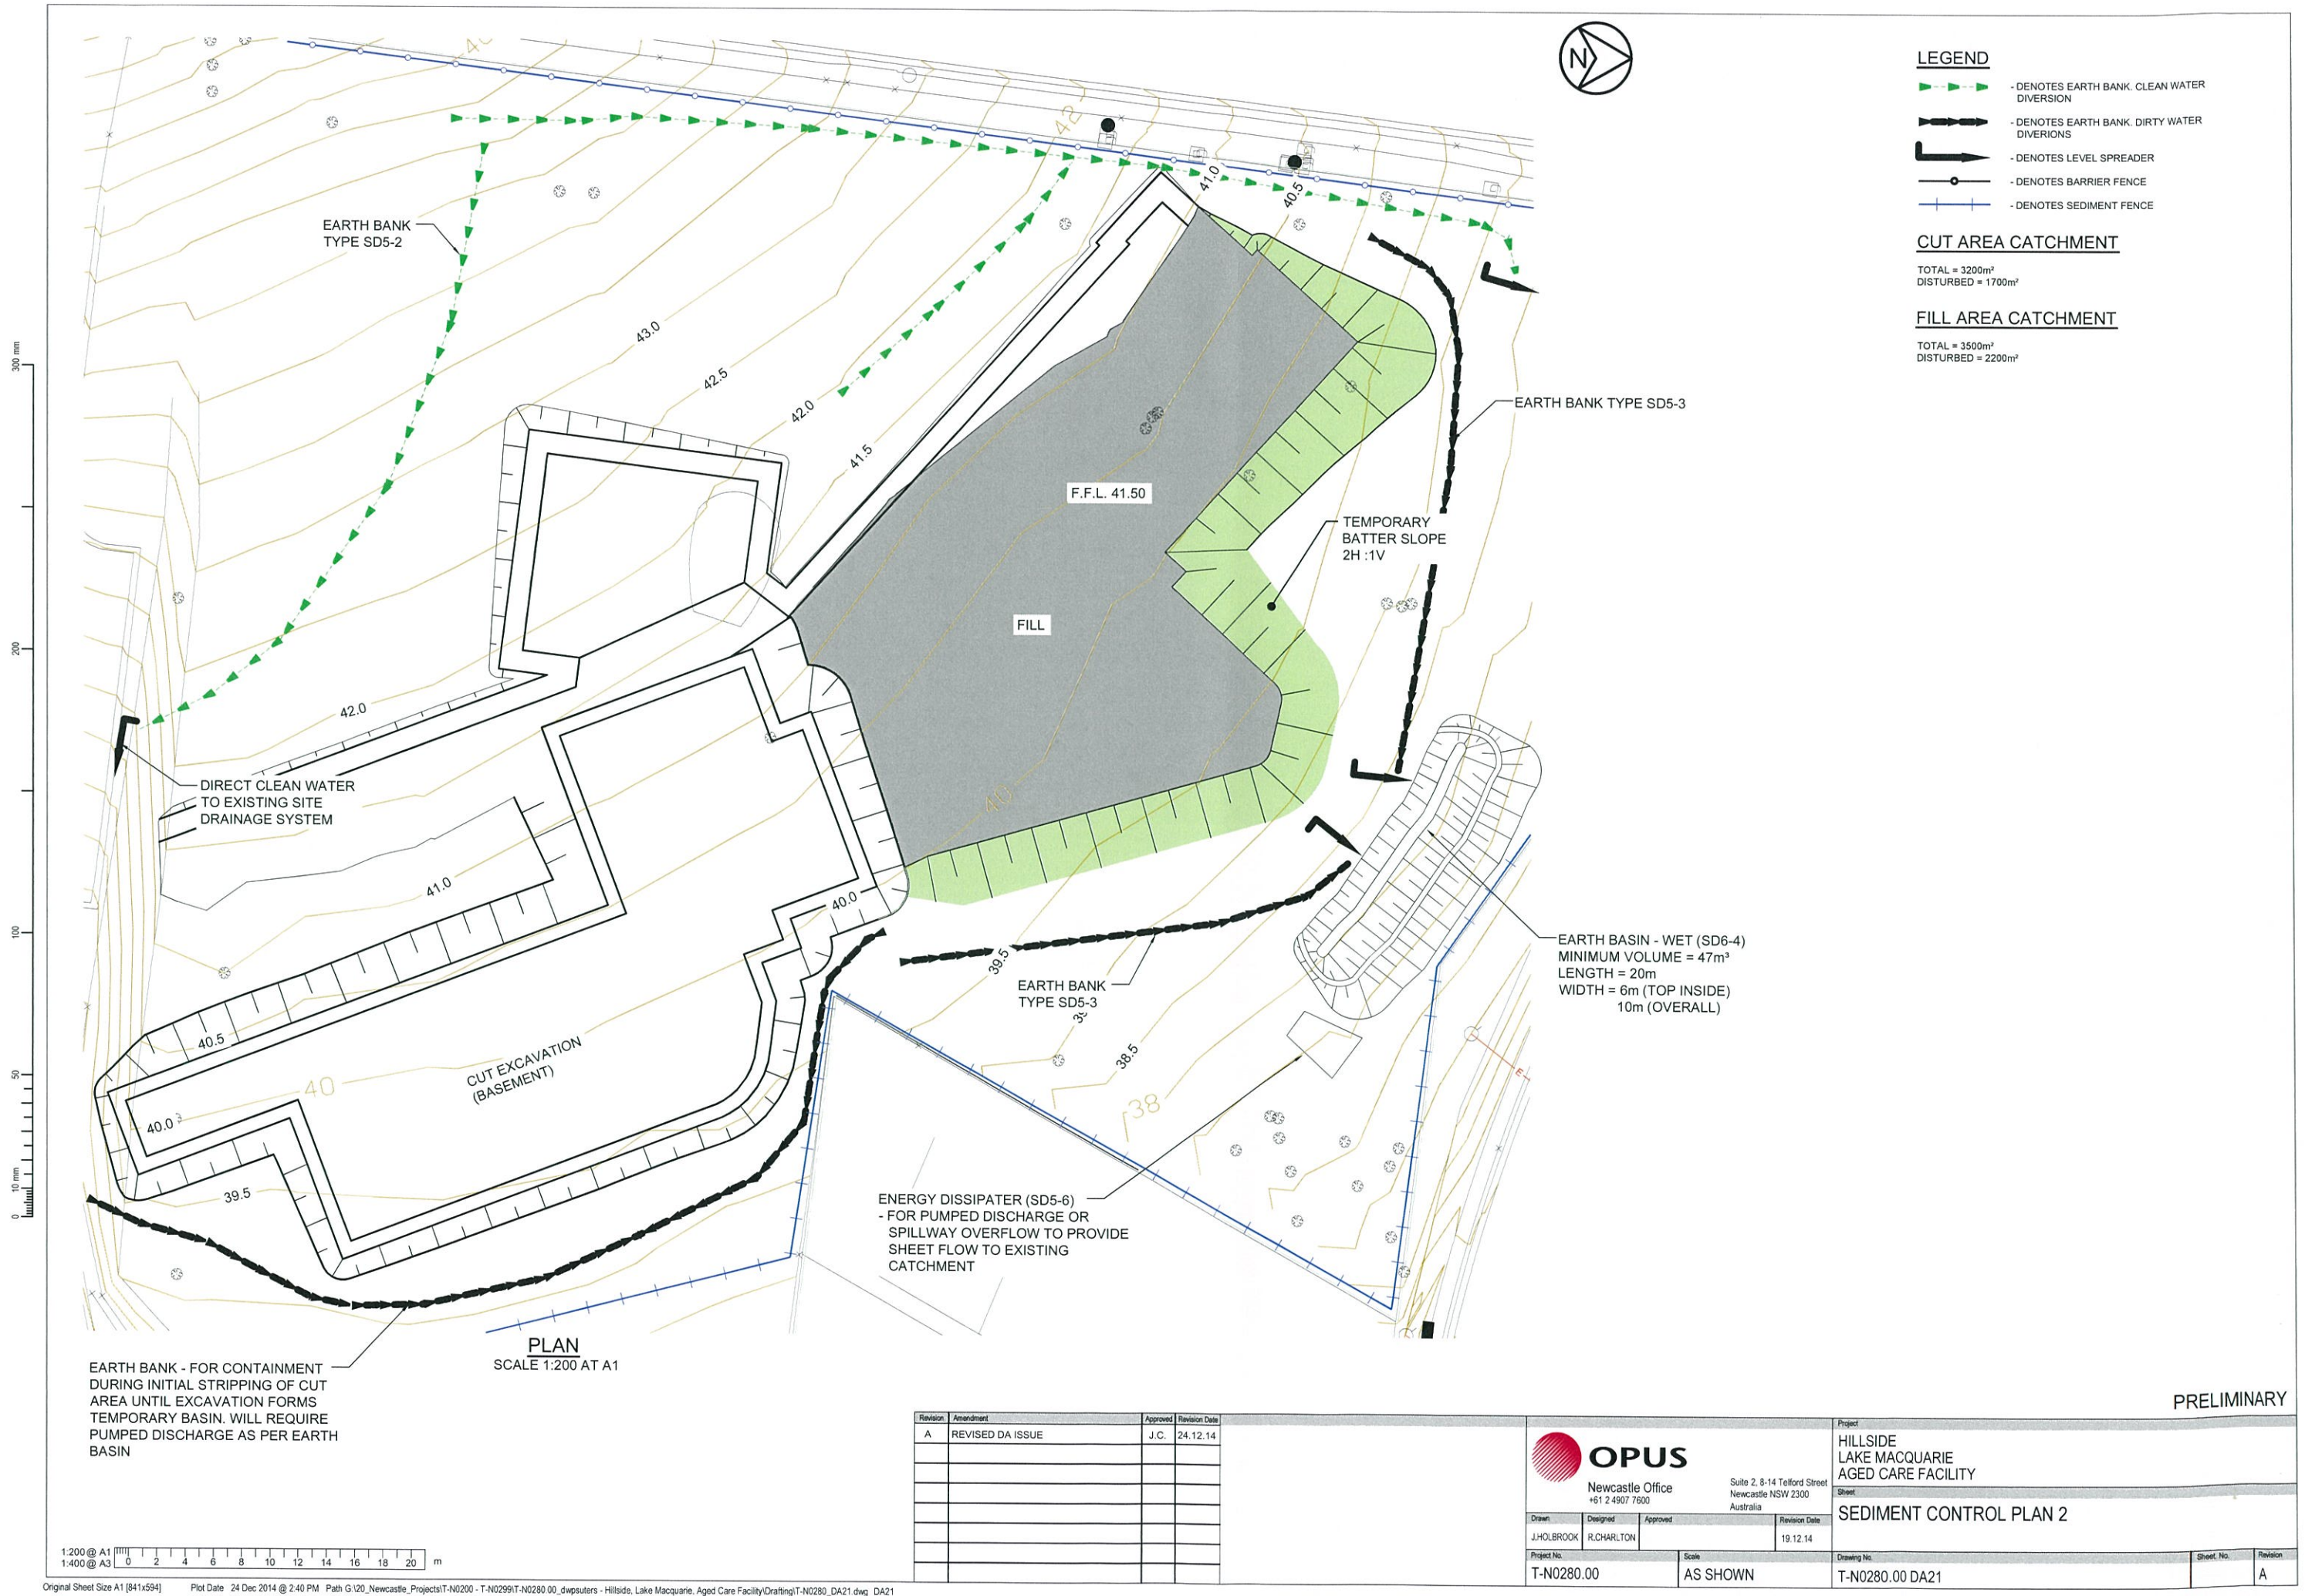

- LEGEND**
- DENOTES EARTH BANK. CLEAN WATER DIVERSION
  - DENOTES EARTH BANK. DIRTY WATER DIVERSIONS
  - DENOTES LEVEL SPREADER
  - DENOTES BARRIER FENCE
  - DENOTES SEDIMENT FENCE

**CUT AREA CATCHMENT**

TOTAL = 3200m²  
DISTURBED = 1700m²

**FILL AREA CATCHMENT**

TOTAL = 3500m²  
DISTURBED = 2200m²

EARTH BANK - FOR CONTAINMENT DURING INITIAL STRIPPING OF CUT AREA UNTIL EXCAVATION FORMS TEMPORARY BASIN. WILL REQUIRE PUMPED DISCHARGE AS PER EARTH BASIN

PLAN  
SCALE 1:200 AT A1

Revision	Amendment	Approved	Revision Date
A	REVISED DA ISSUE	J.C.	24.12.14



Project HILLSIDE LAKE MACQUARIE AGED CARE FACILITY		Sheet SEDIMENT CONTROL PLAN 2	
Drawn J.HOLBROOK	Designed R.CHARLTON	Approved 	Revision Date 19.12.14
Project No. T-N0280.00	Scale AS SHOWN	Drawing No. T-N0280.00 DA21	Sheet No. A







SEDIMENT AND EROSION CONTROL

1. THE CONTRACTOR IS TO PROVIDE MEASURES AS REQUIRED TO SUIT HIS STAGING, WORK METHODS & REQUIREMENTS OF COUNCIL AND THE 'BLUEBOOK' (NSW DEPT HOUSING- MANAGING URBAN STORMWATER SOILS AND CONSTRUCTION). THE CONTRACTOR IS ALSO TO PROVIDE & MAINTAIN EFFECTIVE DUST CONTROL MEASURES TO THE ABOVE AUTHORITIES SATISFACTION.
2. THE WORKS ARE TO BE UNDERTAKEN WITH SEDIMENT & EROSION CONTROL MEASURES IN ACCORDANCE WITH COUNCIL'S REQUIREMENTS
3. THE CONTRACTOR SHALL BE RESPONSIBLE FOR IMPLEMENTING ALL REQUIRED SEDIMENT AND EROSION CONTROL MEASURES AND FOR THE MAINTENANCE AND ONGOING OPERATION OF ALL CONTROL MEASURES. ALL CONTROL FEATURES ARE TO BE REGULARLY INSPECTED TO ENSURE CORRECT OPERATION.
4. SEDIMENT AND EROSION CONTROL MEASURES AS REQUIRED SHALL BE CARRIED OUT FOR THE FULL DURATION OF THE WORKS BY THE CONTRACTOR.
5. THE ESCP/SWMP AND ITS ASSOCIATED EROSION AND SEDIMENT CONTROL MEASURES SHALL BE CONSTANTLY MONITORED, REVIEWED, AND MODIFIED AS REQUIRED TO CORRECT DEFICIENCIES. COUNCIL HAS THE RIGHT TO REQUEST CHANGES IF, IN ITS OPINION, THE MEASURES THAT ARE PROPOSED OR HAVE BEEN INSTALLED ARE INADEQUATE TO PREVENT POLLUTION.
6. PRIOR TO ANY ACTIVITIES ONSITE, THE RESPONSIBLE PERSON(S) IS TO BE NOMINATED. THE RESPONSIBLE PERSON(S) SHALL BE RESPONSIBLE FOR THE EROSION AND SEDIMENT CONTROL (ESC) MEASURES ONSITE. THE NAME, ADDRESS AND 24 HOUR CONTACT DETAILS OF THE PERSON(S) SHALL BE PROVIDED TO COUNCIL IN WRITING. COUNCIL SHALL BE ADVISED WITHIN 48 HOURS OF ANY CHANGES TO THE RESPONSIBLE PERSON(S), OR THEIR CONTACT DETAILS, IN WRITING.
7. NO SITE WORKS SHALL COMMENCE PRIOR TO THE APPROVAL OF THE DETAILED ENGINEERING DESIGN. ITS IMPLEMENTATION SHALL BE SUPERVISED BY PERSONNEL WITH APPROPRIATE QUALIFICATIONS AND/OR EXPERIENCE IN ESC ON CONSTRUCTION SITES.
8. THE APPROVED SWMP SHALL BE AVAILABLE ON-SITE FOR INSPECTION BY COUNCIL OFFICERS WHILE WORK ACTIVITIES ARE OCCURRING.
9. ALL ESC MEASURES SHALL BE APPROPRIATE FOR THE SEDIMENT TYPE(S) OF THE SOILS ONSITE, IN ACCORDANCE WITH THE BLUE BOOK (MANAGING URBAN STORMWATER - SOILS AND CONSTRUCTION. LANDCOM, 2004), OR OTHER CURRENT RECOGNISED INDUSTRY STANDARD FOR EROSION AND SEDIMENT CONTROL FOR AUSTRALIAN CONDITIONS. THIS INCLUDES SEDIMENT TRAPS AND LINING OF CHANNELS.
10. ADEQUATE SITE DATA, INCLUDING SOIL DATA FROM A NATA APPROVED LABORATORY, SHALL BE OBTAINED TO ALLOW THE PREPARATION OF AN APPROPRIATE SWMP, AND ALLOW THE SELECTION, DESIGN AND SPECIFICATION OF REQUIRED ESC MEASURES.
11. THE SWMP SHALL CLEARLY STATE THAT NO LAND-DISTURBING ACTIVITIES ON THE SITE SHALL OCCUR UNTIL ALL PERIMETER ESC MEASURES, SEDIMENT BASINS, AND ASSOCIATED TEMPORARY DRAINAGE CONTROLS, HAVE BEEN CONSTRUCTED AND ARE FULLY OPERATIONAL, IN ACCORDANCE WITH CURRENT BEST PRACTICE ESC. THIS IS UNLESS SUCH CLEARING IS REQUIRED FOR THE PURPOSE OF INSTALLING SUCH MEASURES, IN WHICH CASE ONLY THE MINIMUM CLEARING REQUIRED TO INSTALL SUCH MEASURES SHALL OCCUR.
12. ADDITIONAL ESC MEASURES SHALL BE IMPLEMENTED, AND A REVISED SWMP IS TO BE SUBMITTED FOR APPROVAL TO THE CERTIFIER (WITHIN FIVE (5) BUSINESS DAYS OF ANY SUCH AMENDMENTS) IN THE EVENT THAT:
- a) THERE IS A HIGH PROBABILITY THAT SERIOUS OR MATERIAL ENVIRONMENTAL HARM MAY OCCUR AS A RESULT OF SEDIMENT LEAVING THE SITE; OR
- b) THE IMPLEMENTED WORKS FAIL TO ACHIEVE COUNCIL'S WATER QUALITY OBJECTIVES SPECIFIED IN THESE CONDITIONS; OR
- c) SITE CONDITIONS SIGNIFICANTLY CHANGE; OR
- d) SITE INSPECTIONS INDICATE THAT THE IMPLEMENTED WORKS ARE FAILING TO ACHIEVE THE "OBJECTIVE" OF THE SWMP.
13. A COPY OF ANY AMENDED SWMP SHALL BE FORWARDED TO AN APPROPRIATE COUNCIL OFFICER, WITHIN FIVE (5) BUSINESS DAYS OF ANY SUCH AMENDMENTS.
14. ALL OFFICE FACILITIES AND OPERATIONAL ACTIVITIES SHALL BE LOCATED SUCH THAT ANY EFFLUENT, INCLUDING WASH-DOWN WATER, CAN BE TOTALLY CONTAINED AND TREATED WITHIN THE SITE.
15. ALL REASONABLE AND PRACTICABLE MEASURES SHALL BE TAKEN TO ENSURE STORMWATER RUNOFF FROM ACCESS ROADS AND STABILISED ENTRY/EXIT SYSTEMS, DRAINS TO AN APPROPRIATE SEDIMENT CONTROL DEVICE.
16. ALL WORKS SHALL BE CARRIED OUT IN ACCORDANCE WITH THE APPROVED SWMP (AS AMENDED FROM TIME TO TIME) UNLESS CIRCUMSTANCES ARISE WHERE:
- a) COMPLIANCE WITH THE SWMP WOULD INCREASE THE POTENTIAL FOR ENVIRONMENTAL HARM AS ASSESSED BY AN AUTHORITY RECOGNISED BY COUNCIL; OR
- b) CIRCUMSTANCES CHANGE DURING CONSTRUCTION AND THOSE CIRCUMSTANCES COULD NOT HAVE BEEN FORESEEN; OR
- c) COUNCIL OR ITS REPRESENTATIVE DETERMINES THAT UNACCEPTABLE OFF-SITE SEDIMENTATION IS OCCURRING AS A RESULT OF A LAND-DISTURBING ACTIVITY. IN EITHER CASE, THE PERSON(S) RESPONSIBLE MAY BE REQUIRED TO TAKE ADDITIONAL, OR ALTERNATIVE PROTECTIVE ACTION, AND/OR UNDERTAKE REASONABLE RESTORATION WORKS WITHIN THE TIMEFRAME SPECIFIED BY THE COUNCIL.
17. THE APPLICANT SHALL ENSURE AN ADEQUATE SUPPLY OF ESC, AND APPROPRIATE POLLUTION CLEAN-UP MATERIALS ARE AVAILABLE ON-SITE AT ALL TIMES.
18. SEDIMENT DEPOSITED OFF SITE AS A RESULT OF ON-SITE ACTIVITIES SHALL BE COLLECTED AND THE AREA CLEANED/REHABILITATED AS SOON AS REASONABLE AND PRACTICABLE.
19. CONCRETE WASTE AND CHEMICAL PRODUCTS, INCLUDING PETROLEUM AND OIL-BASED PRODUCTS, SHALL BE PREVENTED FROM ENTERING ANY INTERNAL OR EXTERNAL WATER BODY, OR ANY EXTERNAL DRAINAGE SYSTEM, EXCLUDING THOSE ON-SITE WATER BODIES SPECIFICALLY DESIGNED TO CONTAIN AND/OR TREAT SUCH MATERIAL. APPROPRIATE MEASURES SHALL BE INSTALLED TO TRAP THESE MATERIALS ONSITE.
20. BRICK, TILE OR MASONRY CUTTING SHALL BE CARRIED OUT ON A PERVIOUS SURFACE (E.G. GRASS OR OPEN SOIL), OR IN SUCH A MANNER THAT ANY RESULTING SEDIMENT-LADEN RUNOFF IS PREVENTED FROM DISCHARGING INTO A GUTTER, DRAIN OR WATER. APPROPRIATE MEASURES SHALL BE INSTALLED TO TRAP THESE MATERIALS ONSITE.

SEDIMENT AND EROSION CONTROL CONTINUED

21. NEWLY SEALED HARD-STAND AREAS (E.G. ROADS, DRIVEWAYS AND CAR PARKS) SHALL BE SWEEPED THOROUGHLY AS SOON AS PRACTICABLE AFTER SEALING/SURFACING TO MINIMISE THE RISK OF COMPONENTS OF THE SURFACING COMPOUND ENTERING STORMWATER DRAINS.
22. STOCKPILES OF ERODIBLE MATERIAL SHALL BE PROVIDED WITH AN APPROPRIATE PROTECTIVE COVER (SYNTHETIC OR ORGANIC) IF THE MATERIALS ARE LIKELY TO BE STOCKPILED FOR MORE THAN 10 DAYS.
23. STOCKPILES, TEMPORARY OR PERMANENT, SHALL NOT BE LOCATED IN AREAS IDENTIFIED AS NO-GO ZONES (INCLUDING, BUT NOT LIMITED TO, RESTRICTED ACCESS AREAS, BUFFER ZONES, OR AREAS OF NON-DISTURBANCE) ON THE ESCP/SWMP;
24. BULK TREE CLEARING AND GRUBBING OF THE SITE SHALL BE IMMEDIATELY FOLLOWED BY SPECIFIED TEMPORARY EROSION CONTROL MEASURES (E.G. TEMPORARY GRASSING OR MULCHING) PRIOR TO COMMENCEMENT OF EACH STAGE OF CONSTRUCTION WORKS;
25. TREES AND VEGETATION CLEARED FROM THE SITE SHALL BE MULCHED ONSITE WITHIN 7 DAYS OF CLEARING;
26. APPROPRIATE MEASURES SHALL BE UNDERTAKEN TO CONTROL ANY DUST ORIGINATING DUE TO THE MULCHING OF VEGETATION ONSITE;
27. PRIORITY SHALL BE GIVEN TO THE PREVENTION, OR AT LEAST THE MINIMISATION, OF SOIL EROSION, RATHER THAN THE TRAPPING OF DISPLACED SEDIMENT. SUCH A CLAUSE SHALL NOT REDUCE THE RESPONSIBILITY TO APPLY AND MAINTAIN, AT ALL TIMES, ALL NECESSARY SEDIMENT CONTROL MEASURES.
28. MEASURES USED TO CONTROL WIND EROSION SHALL BE APPROPRIATE FOR THE LOCATION AND PREVENT SOIL EROSION AT ALL TIMES, INCLUDING WORKING HOURS, OUT OF HOURS, WEEKENDS, PUBLIC HOLIDAYS, AND DURING ANY OTHER SHUTDOWN PERIODS.
29. THE APPLICATION OF LIQUID OR CHEMICAL-BASED DUST SUPPRESSION MEASURES SHALL ENSURE THAT SEDIMENT-LADEN RUNOFF RESULTING FROM SUCH MEASURES (E.G. RUNOFF OF EXCESS WATER) DOES NOT CREATE A TRAFFIC OR ENVIRONMENTAL HAZARD.
30. ALL TEMPORARY EARTH BANKS, FLOW DIVERSION SYSTEMS, AND SEDIMENT BASIN EMBANKMENTS SHALL BE MACHINE-COMPACTED, SEEDED AND MULCHED WITHIN TEN (10) DAYS OF FORMATION FOR THE PURPOSE OF ESTABLISHING A VEGETATIVE COVER, OR LINED APPROPRIATELY.
31. PRIOR TO THE CONTROLLED DISCHARGE (E.G. DE-WATERING ACTIVITIES FROM EXCAVATIONS AND SEDIMENT BASINS) OF ANY WATER FROM THE SITE DURING CONSTRUCTION, THE FOLLOWING WATER QUALITY OBJECTIVES SHALL BE ACHIEVED:
- a) TOTAL SUSPENDED SOLIDS (TSS) TO A MAXIMUM 50MG/L;
- b) WATER PH BETWEEN 6.5 AND 8.5 UNLESS OTHERWISE REQUIRED BY THE COUNCIL; AND
- c) EC LEVELS NO GREATER THAN BACKGROUND LEVELS.
32. PRIOR TO THE ISSUING OF A CONSTRUCTION CERTIFICATE, THE SITE MANAGER SHALL OBTAIN THE RELEVANT APPROVALS FROM THE RELEVANT ORGANISATIONS TO DISCHARGE TREATED WATER FROM ANY EXISTING BASINS. ORGANISATIONS, MAY INCLUDE BUT NOT BE LIMITED TO, HUNTER WATER, AND COUNCIL.
33. PRIOR TO ANY FORECAST WEATHER EVENT LIKELY TO RESULT IN SEDIMENT LADEN RUNOFF ON THE SITE, ANY EXISTING DETENTION BASINS/TRAPS SHALL BE DEWATERED TO PROVIDE SUFFICIENT CAPACITY TO CAPTURE SEDIMENT LADEN WATER FROM THE SITE PRIOR TO THE WEATHER EVENT.
34. ANY SEDIMENT LADEN WATER CAPTURED ONSITE SHALL BE TREATED TO ENSURE IT SHALL ACHIEVE COUNCIL'S WATER QUALITY OBJECTIVES SPECIFIED IN THESE CONDITIONS, PRIOR TO ITS RELEASE FROM SITE. A SAMPLE OF THE RELEASED TREATED WATER SHALL BE KEPT ONSITE IN A CLEAR CONTAINER WITH THE SAMPLE DATE RECORDED ON IT.
35. NO ALUMINIUM BASED PRODUCTS MAY BE USED TREAT TURBID WATER (FLOCCULATING/COAGULANTS) ONSITE WITHOUT THE PRIOR WRITTEN PERMISSION FROM AN APPROPRIATE COUNCIL OFFICER. THE APPLICANT SHALL HAVE A DEMONSTRATED ABILITY TO USE SUCH PRODUCTS CORRECTLY AND WITHOUT ENVIRONMENTAL HARM PRIOR TO ANY APPROVAL.
36. THE CHEMICAL/AGENT (FLOCCULATING/COAGULANTS) USED IN TYPE D AND TYPE F BASINS TO TREAT TURBID WATER CAPTURED IN THE BASIN SHALL BE APPLIED IN CONCENTRATIONS SUFFICIENT TO ACHIEVE COUNCIL'S WATER QUALITY OBJECTIVES, SPECIFIED IN THESE CONDITIONS, WITHIN THE 5-DAY RAINFALL DEPTH USED TO CALCULATE THE CAPACITY OF THE BASIN, AFTER A RAINFALL EVENT.
37. ALL MANUFACTURER'S INSTRUCTIONS SHALL BE FOLLOWED FOR THE USE OF ANY CHEMICALS/AGENTS USED ONSITE, EXCEPT WHERE APPROVED BY THE RESPONSIBLE PERSON OR AN APPROPRIATE COUNCIL OFFICER.
38. SUFFICIENT QUANTITIES OF CHEMICALS/AGENTS TO TREAT TURBID WATER (FLOCCULATING/COAGULANTS) SHALL BE PLACED SUCH THAT WATER ENTERING THE BASIN/SEDIMENT TRAP MIXES WITH THE CHEMICAL/AGENTS AND IS CARRIED INTO THE BASIN/TRAP.
39. ANY BASIN SHALL BE DEWATERED AS SOON AS PRACTICAL. ONCE WATER CAPTURED IN THE BASIN ACHIEVES COUNCIL'S WATER QUALITY OBJECTIVES, SPECIFIED IN THESE CONDITIONS.
40. SUFFICIENT QUANTITIES OF CHEMICALS/AGENTS TO TREAT TURBID WATER (FLOCCULATING/COAGULANTS) SHALL BE SECURELY STORED ON-SITE TO PROVIDE FOR AT LEAST THREE COMPLETE TREATMENTS OF ALL BASINS REQUIRING CHEMICALLY TREATMENT ONSITE.
41. THE APPLICANT SHALL ENSURE THAT ON EACH OCCASION A TYPE F OR TYPE D BASIN WAS NOT DE-WATERED PRIOR TO BEING SURCHARGED BY A FOLLOWING RAINFALL EVENT, A REPORT IS PRESENTED TO AN APPROPRIATE COUNCIL OFFICER WITHIN 5 DAYS IDENTIFYING THE CIRCUMSTANCES AND PROPOSED AMENDMENTS, IF ANY, TO THE BASIN'S OPERATING PROCEDURES.
42. AS-CONSTRUCTED PLANS SHALL BE PREPARED FOR ALL CONSTRUCTED SEDIMENT BASINS AND ASSOCIATED EMERGENCY SPILLWAYS. SUCH PLANS SHALL APPROPRIATELY VERIFY THE BASIN'S DIMENSIONS, LEVELS AND VOLUMES COMPLY WITH THE APPROVED DESIGN DRAWINGS. THESE PLANS SHALL BE SUBMITTED TO COUNCIL WITHIN 14 CALENDAR DAYS OF THE CONSTRUCTION OF EACH BASIN, IF REQUESTED BY THE CERTIFIER, OR COUNCIL.

SEDIMENT AND EROSION CONTROL CONTINUED

43. WHERE MORE THAN ONE STAGE IS TO BE DEVELOPED AT ONE TIME, OR BEFORE THE PRECEDING STAGE IS COMPLETE, THE SEDIMENT BASIN(S) FOR THESE STAGES SHALL HAVE SUFFICIENT CAPACITY TO CATER FOR ALL AREA DIRECTED TO THE BASIN(S).
44. ALL SEDIMENT BASINS SHALL REMAIN FULLY OPERATIONAL AT ALL TIMES UNTIL THE BASIN'S DESIGN CATCHMENT ACHIEVES 70% GROUND COVERAGE, OR SURFACE STABILISATION CATCHMENT TO COUNCIL.
45. SETTLED SEDIMENT SHALL BE REMOVED AS SOON AS REASONABLE AND PRACTICABLE FROM ANY SEDIMENT BASIN IF:
- a) IT IS ANTICIPATED THAT THE NEXT STORM EVENT IS LIKELY TO CAUSE SEDIMENT TO SETTLE ABOVE THE BASIN'S SEDIMENT STORAGE ZONE; OR
- b) THE ELEVATION OF SETTLED SEDIMENT IS ABOVE THE TOP OF THE BASIN'S SEDIMENT STORAGE ZONE; OR
- c) THE ELEVATION OF SETTLED SEDIMENT IS ABOVE THE BASIN'S SEDIMENT MARKER LINE.
46. SCOUR PROTECTION MEASURES PLACED ON SEDIMENT BASIN EMERGENCY SPILLWAYS SHALL APPROPRIATELY PROTECT THE SPILLWAY CHUTE AND ITS SIDE BATTERS FROM SCOUR, AND SHALL EXTEND A MINIMUM OF 3M BEYOND THE DOWNSTREAM TOE OF THE BASIN'S EMBANKMENT.
47. SUITABLE ALL-WEATHER MAINTENANCE ACCESS SHALL BE PROVIDED TO ALL SEDIMENT CONTROL DEVICES.
48. ALL SEDIMENT CONTROL DEVICES (OTHER THAN SEDIMENT BASINS) SHALL BE DE-SILTED AND MADE FULLY OPERATIONAL AS SOON AS REASONABLE AND PRACTICABLE AFTER RUNOFF-PRODUCING RAINFALL, OR IF THE SEDIMENT RETENTION CAPACITY OF THE DEVICE FALLS BELOW 75% OF THE DESIGN RETENTION CAPACITY.
49. ALL CUT AND FILL EARTH BATTERS LESS THAN 3M IN ELEVATION SHALL BE TOPSOILED, AND GRASS SEEDED/HYDROMULCHED WITHIN 10 DAYS OF COMPLETION OF GRADING IN CONSULTATION WITH COUNCIL.
50. THE PH LEVEL OF TOPSOIL SHALL BE APPROPRIATE TO ENABLE ESTABLISHMENT AND GROWTH OF SPECIFIED VEGETATION PRIOR TO INITIATING THE ESTABLISHMENT OF VEGETATION.
51. SOIL AMELIORANTS SHALL BE ADDED TO THE SOIL IN ACCORDANCE WITH AN APPROVED LANDSCAPE PLAN, VEGETATION MANAGEMENT PLAN, AND/OR SOIL ANALYSIS.
52. SURFACE SOIL DENSITY, COMPACTION AND SURFACE ROUGHNESS SHALL BE ADJUSTED PRIOR TO SEEDING/PLANTING IN ACCORDANCE WITH AN APPROVED LANDSCAPE PLAN, VEGETATION MANAGEMENT PLAN, AND/OR SOIL ANALYSIS.
53. PROCEDURES FOR INITIATING A SITE SHUTDOWN, WHETHER PROGRAMMED OR UN-PROGRAMMED, SHALL INCORPORATE REVEGETATION OF ALL SOIL DISTURBANCES UNLESS OTHERWISE APPROVED BY COUNCIL.
54. THE APPLICANT SHALL ENSURE THAT APPROPRIATE PROCEDURES AND SUITABLY QUALIFIED PERSONNEL ARE ENGAGED TO PLAN AND CONDUCT SITE INSPECTIONS AND WATER QUALITY MONITORING THROUGHOUT THE CONSTRUCTION AND MAINTENANCE PHASE.
55. ALL ESC MEASURES SHALL BE INSPECTED:
- a) AT LEAST DAILY (WHEN WORK IS OCCURRING ON-SITE); AND
- b) AT LEAST WEEKLY (WHEN WORK IS NOT OCCURRING ON-SITE); AND
- c) WITHIN 24HRS OF EXPECTED RAINFALL; AND
- d) WITHIN 18HRS OF A RAINFALL EVENT THAT CAUSES RUNOFF ON THE SITE.
56. WRITTEN RECORDS SHALL BE KEPT ONSITE OF ESC MONITORING AND MAINTENANCE ACTIVITIES CONDUCTED DURING THE CONSTRUCTION AND MAINTENANCE PERIODS, AND BE AVAILABLE TO COUNCIL OFFICERS ON REQUEST.
57. ALL SITE MONITORING DATA INCLUDING RAINFALL RECORDS, DATES OF WATER QUALITY TESTING, TESTING RESULTS AND RECORDS OF CONTROLLED WATER RELEASES FROM THE SITE, SHALL BE KEPT IN AN ON-SITE REGISTER. THE REGISTER IS TO BE MAINTAINED UP TO DATE FOR THE DURATION OF THE APPROVED WORKS AND BE AVAILABLE ON-SITE FOR INSPECTION BY COUNCIL OFFICERS ON REQUEST.
58. SEDIMENT BASIN WATER QUALITY SAMPLES SHALL BE TAKEN AT A DEPTH NO LESS THAN 200MM BELOW THE WATER SURFACE WITHIN THE BASIN.
59. ALL ENVIRONMENTAL INCIDENTS SHALL BE RECORDED IN A FIELD LOG THAT SHALL REMAIN ACCESSIBLE TO ALL RELEVANT REGULATORY AUTHORITIES ON REQUEST.
60. ALL MATERIALS REMOVED FROM ESC DEVICES DURING MAINTENANCE, OR DECOMMISSIONING, WHETHER SOLID OR LIQUID, SHALL BE DISPOSED OF IN A MANNER THAT DOES NOT CAUSE ANY ONGOING EROSION OR POLLUTION HAZARD.
61. CONSTRUCTION CONTRACTOR IS TO STAGE WORKS TO MINIMISE EXTENT OF DISTURBED AREAS AT ANY ONE TIME.
62. ALL AREAS AND SIZES TO BE CONFIRMED DURING DETAILED DESIGN.

SEDIMENTATION BASIN SIZING CALCULATIONS

1. THE PRELIMINARY SEDIMENT BASIN SIZING CALCULATIONS HAVE BEEN UNDERTAKEN IN ACCORDANCE WITH THE "BLUE BOOK".

1. Erosion Hazard and Sediment Basins

Site Name: Hillside, Lake Macquarie, Aged Care Facility

Site Location: 3 Violet Town Road, Mount Hutton

Precinct/Stage: DA submission

Other Details: NSWBlueBook - Appendix C "Table 17- GosfordLakeMacquarie Soil Landscapes - Warners Bay (wa), Sediment Type D, K-factor =

Site area	Sub-catchment or Name of Structure	Notes
Total catchment area (ha)	0.35	
Disturbed catchment area (ha)	0.22	

Soil analysis (enter sediment type if known, or laboratory particle size data)					
Sediment Type (C, F or D) if known	D				From Appendix C (if known)
% sand (fraction 0.02 to 2.0 mm)					Enter the percentage of each soil fraction. E.g. enter 10 for 10%
% silt (fraction 0.002 to 0.02 mm)					
% clay (fraction finer than 0.002 mm)					
Dispersion percentage					E.g. enter 10 for dispersion of 10%
% of whole soil dispersible					See Section 6.3.3(e). Auto-calculated
Soil Texture Group	D				Automatic calculation from above

Rainfall data					
Design rainfall depth (no. of day s)	5				See Section 6.3.4 and, particularly, Table 6.3 on pages 6-24 and 6-25
Design rainfall depth (percentile)	75				
x-dor. y percentile rainfall event (mm)	24.4				
Rainfall R factor (if known)					Only need to enter one or the other here
IPD 2 year, 6-hour storm (if known)	12				

RUSLE Factors					
Rainfall erosivity (R factor)	3110				Auto-filled from above
Soil erodibility (K factor)	0.019				
Slope length (m)	50				
Slope gradient (%)	10				RUSLE LS factor calculated for a high rill/interill ratio
Length/gradient (LS factor)	2.04				
Erosion control practice (P factor)	1.3	1.3	1.3	1.3	1.3
Ground cover (C factor)	1	1	1	1	1

Sediment Basin Design Criteria (for Type D/F basins only. Leave blank for Type C basins)					
Storage (soil) zone design (no. of months)	2				Minimum is generally 2 months
Cv (Volumetric runoff coefficient)	0.5				See Table F2, page F-4 in Appendix F

Calculations and Type D/F Sediment Basin Volumes					
Soil loss (t/ha/yr)	156				
Soil Loss Class	2				See Table 4.2, page 4-13
Soil loss (m <sup>3</sup> /ha/yr)	120				Conversion to cubic metres
Sediment basin storage (soil) volume (m <sup>3</sup> )	4				See Sections 6.3.4(i) for calculations
Sediment basin settling (water) volume (m <sup>3</sup> )	43				See Sections 6.3.4(i) for calculations
Sediment basin total volume (m <sup>3</sup> )	47				

NB for sizing of Type C (coarse) sediment basins, see Worksheet 3 (if required)

IMPLEMENTATION OF EROSION AND SEDIMENT CONTROL MEASURES

61. THE PRELIMINARY IMPLEMENTATION SCHEDULE FOR THE EROSION AND SEDIMENTATION MEASURES IS AS PER THE SCHEDULE BELOW FOR THE DA SUBMISSION. THE DETAILED SCHEDULE MUST BE UNDERTAKEN BY THE CONSTRUCTION CONTRACTOR WHEN THE FULL AND APPROVED EXTENT OF CONSTRUCTION WORK IS KNOWN AND TO SUIT THE CONSTRUCTION CONTRACTORS WORK METHODS AND STAGING OF WORKS AND DISTURBANCE OF GROUND. THIS SCHEDULE AND THE CONTRACTORS WORKS MUST FOLLOW THE REQUIREMENTS OF THE NSW 'BLUE BOOK'
62. INSTALL ALL SEDIMENT FENCES, KERB INLET PROTECTION, AND CONSTRUCTION ENTRY PRIOR TO ANY DISTURBANCE WORKS BEING UNDERTAKEN.
63. INSTALL ALL CLEAN WATER DIVERSIONS.
64. INSTALL DIRTY WATER DIVERSIONS, SEDIMENT BASIN AND ENERGY DISSIPATER PRIOR TO UNDERTAKING EARTHWORKS.
65. AFTER COMPLETION OF ALL CONSTRUCTION WORKS AND STABILISATION OF DISTURBED AREAS REMOVAL OF ESC MEASURES IS TO FOLLOW THE REVERSE ORDER TO INSTALLATION.

PRELIMINARY

1:500 @ A1  
1:1000 @ A3

Revision	Amendment	Approved	Revision Date
A	DA ISSUE	-	24.12.14

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Drawn J.HOLBROOK	Designed R.CHARLTON	Approved Revision Date 19.12.14
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